WEST HARRIS COUNTY REGIONAL WATER AUTHORITY SURFACE WATER SUPPLY PROJECT

SEGMENT "X"

PROJECT LIMITS DESCRIPTION



SURFACE WATER SUPPLY PROJECT

WEST HARRIS COUNTY REGIONAL WATER AUTHORITY

BOARD OF DIRECTORS

LARRY A. WEPPLER	DIRECTOR PRECINCT #1
JOHN WHEELER	DIRECTOR PRECINCT #2
ERIC HANSEN	DIRECTOR PRECINCT #3
MICHAEL THORNHILL	DIRECTOR PRECINCT #4
MIKE OWENS	DIRECTOR PRECINCT #5
DOUGLAS C. POSTLE	DIRECTOR PRECINCT #6
GARY STRUZICK	DIRECTOR PRECINCT #7
MARK G. JANNECK	DIRECTOR PRECINCT #8
DENNIS GORDEN	DIRECTOR PRECINCT #9

DESIGN VARIANCE GIVEN BY CITY ENGINEER BY EMAIL DATED 1/22/2019. CITY SIGNATURES DO NOT REPRESENT COMPLIANCE WITH THE CITY'S DESIGN STANDARDS, ONLY ACKNOWLEDGEMENT OF THE PROJECT FOR THE PURPOSES OF CONSTRUCTION AND PERMITTING.

NORTH FORT BEND WATER AUTHORITY BOARD OF DIRECTORS

BRUCE FAY	DIRECTOR PRECINCT #1
ROBERT DARDEN	DIRECTOR PRECINCT #2
DONALD ABRAHAMSON, II	DIRECTOR PRECINCT #3
MELONY F. GAY	DIRECTOR PRECINCT #4
ROBERT L. PATTON	DIRECTOR PRECINCT #5
PETER HOUGHTON	DIRECTOR PRECINCT #6
DANA HOLLINGSWORTH	DIRECTOR PRECINCT #7

CONSTRUCTION ACTIVIES ALLOWED ONLY IN AREAS WHERE THE AUTHORITY HAS EASEMENTS OR THE LEGAL RIGHT TO BE PRESENT

> ONE-CALL NOTIFICATION SYSTEM CALL BEFORE YOU DIG!!! (713) 223-4567 (New Statewide Number Outside Houston) 1-800-545-6005

ILMS NO. C.O.H. LOG. NO.

.) HCFCD RIGHT-OF-WAY NOTIFICATION (PERMIT

XX% SUBMITTAL



3	MM/DD/YY	BRIEF DESCRIPTION	XXX
2	MM/DD/YY	BRIEF DESCRIPTION	XXX
1	MM/DD/YY	BRIEF DESCRIPTION	XXX
NO.	DATE	REVISION	APP.

STORM WATER

TRAFFIC SIGNAL

e purpose of interim review under the

08/31/2019 Engineer of Record Texas Registered Engineering Firm F-#XXX

NOTE: CITY SIGNATURES VALID FOR ONE YEAR ONLY AFTER DATE OF SIGNATURES

CITY OF HOUSTON

HOUSTON PUBLIC WORKS

STORM WATER QUALITY WASTE WATER FACILITIES

> TRAFFIC & TRANSPORTATION/ STREET & BRIDGE

CITY ENGINEER DIRECTOR OF

HOUSTON PUBLIC WORKS

SHEET NO 1 OF XX SHEETS

FOR CITY OF HOUSTON USE ONLY


PROJECT LOCATION


VICINITY MAP

LOCATION MAP

KEY MAP NO. 0000 GIMS MAP NO. 00000 ZIP CODE NO. 00000

ISSUE DATE: MONTH/DAY/YEAR

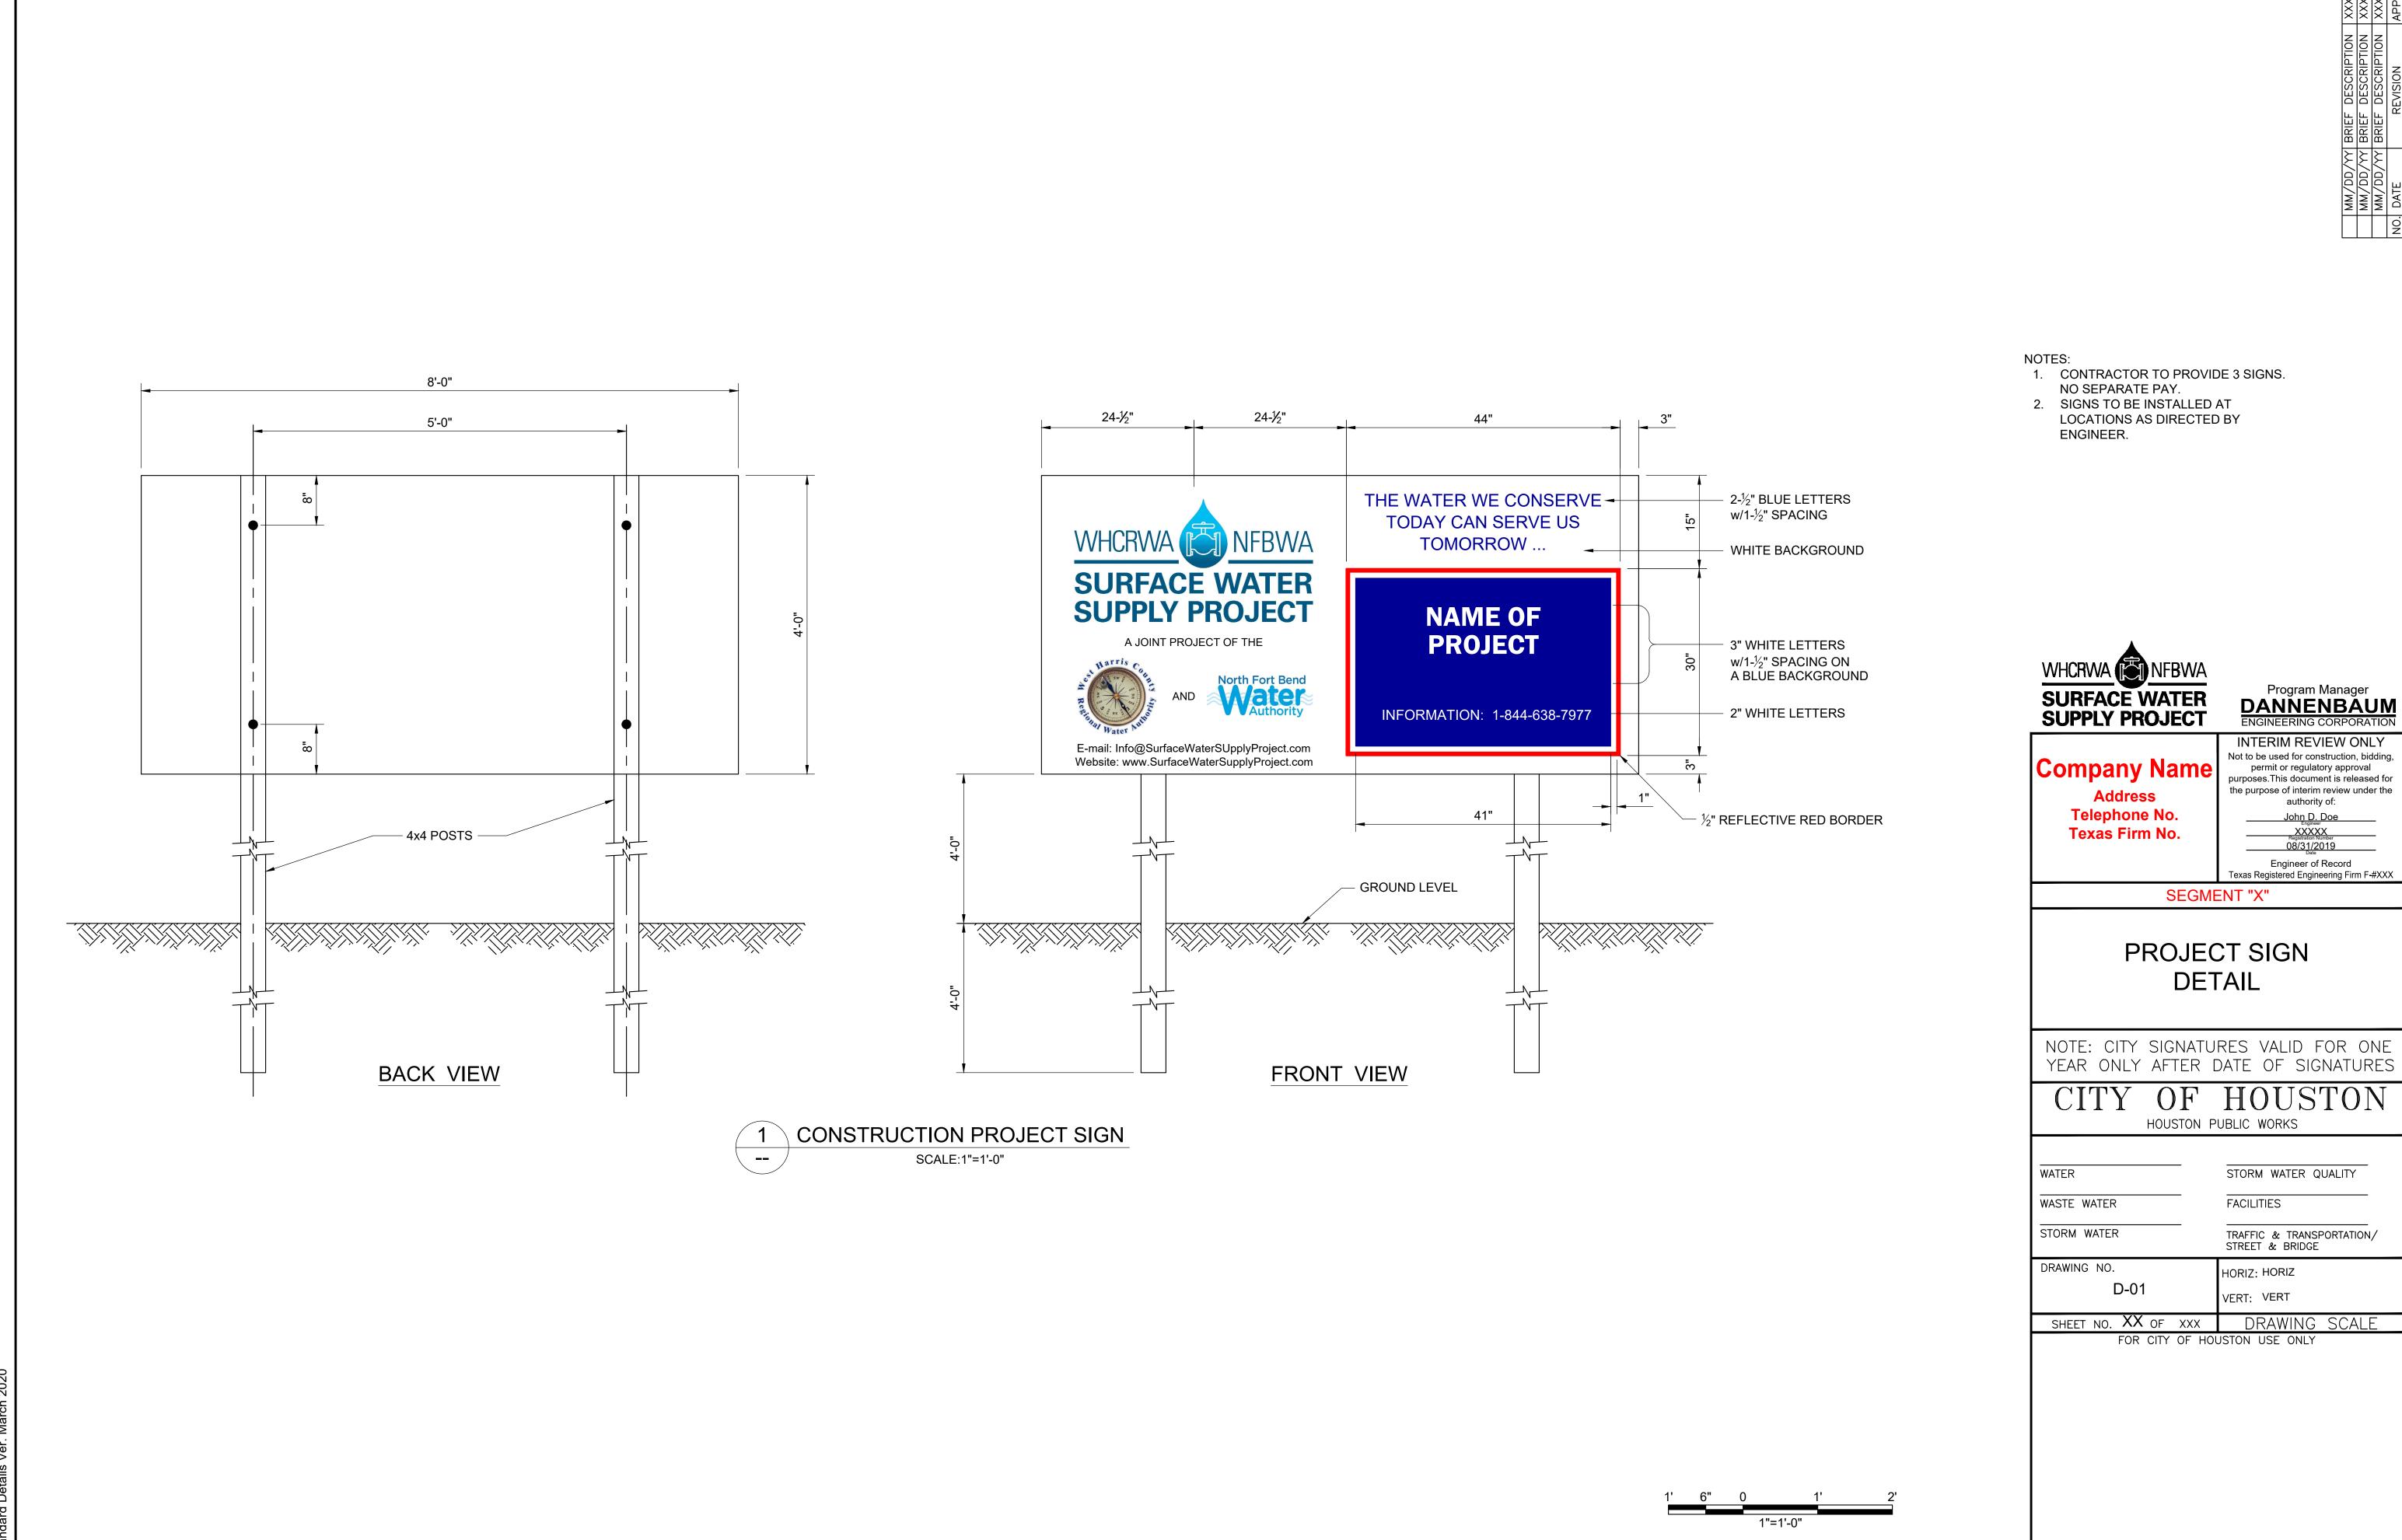


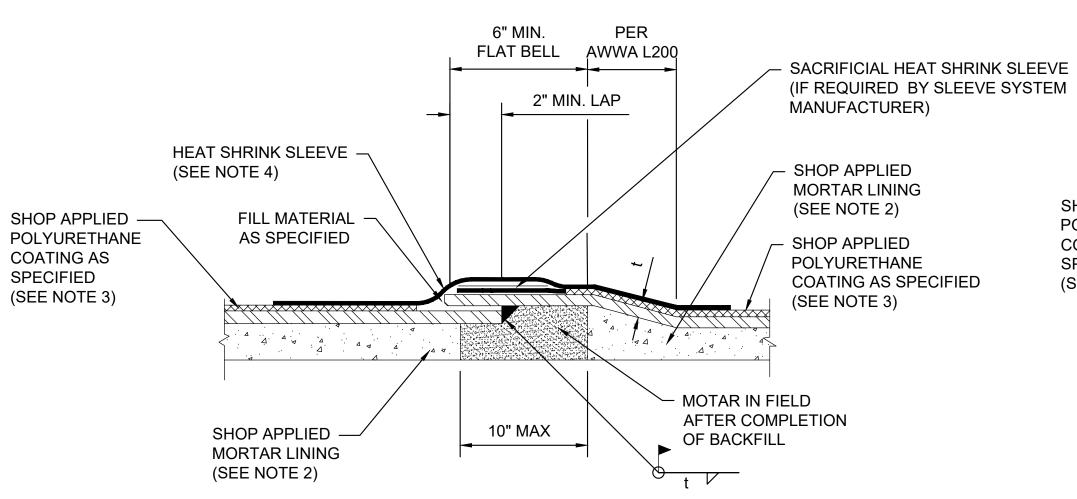

NOTES:

- 2" MIN FROM BELL TANGENT TO WELD.
- 2. HOLD BACK SHOP APPLIED MORTAR LINING MIN. 6 INCHES ON BELL END AND 2 INCHES ON SPIGOT
- 3. HOLD BACK SHOP APPLIED POLYURETHANE COATING MIN. 5 INCHES ON BELL END AND 4 INCHES ON SPIGOT END.
- 4. FIELD APPLY HEAT SHRINK SLEEVE WITH A MINIMUM OVERLAP OF 4" OVER POLYURETHANE COATING.
- 5. "t" INDICATES THE THICKNESS OF THE STEEL PIPE AT THE SECTION WHERE USED.




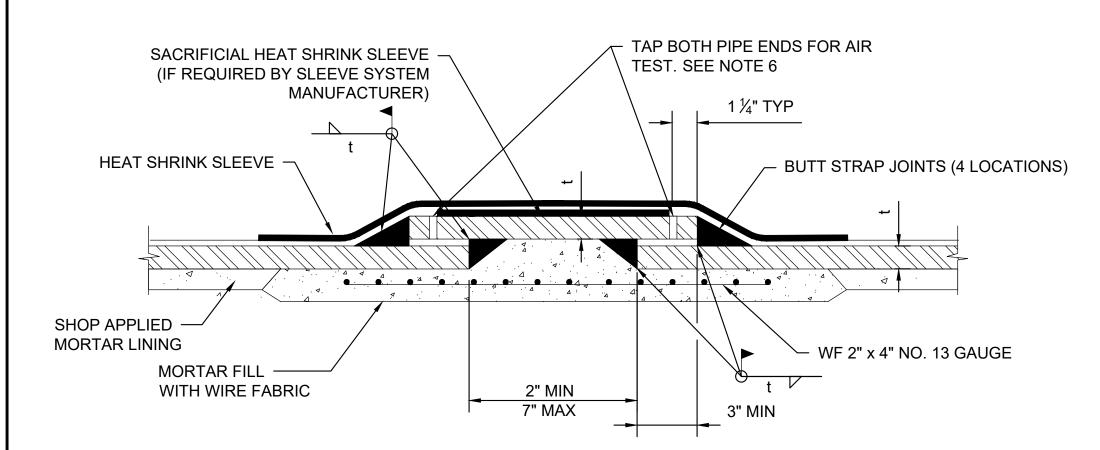

NOTES:

- ALL BUTT STRAP JOINTS SHALL BE WELDED ON THE EXTERIOR AND INTERIOR BOTH ENDS.
- 2. BUTT STRAPS TO BE FURNISHED IN TWO PIECES AND SHIPPED LOOSE FOR FIELD WELDING. BUTT STRAPS TO INCLUDE TABS TO ACCEPT ALL-THREAD FOR BOLTED CONNECTION TO FACILITATE FIELD LINE-UP AND WELDING.
- 3. 12" MAXIMUM LENGTH OF TYPICAL BUTT STRAP FOR FIELD CLOSING SECTION. (SEE SPECIFICATIONS).
- 4. SEE JOINT DETAILS FOR TYPICAL LAP WELD ON POLYURETHANE COATED STEEL PIPE AND FOR ADDITIONAL INFORMATION ON COATINGS, LININGS AND OTHER REQUIREMENTS.
- 5. "t" INDICATES THE THICKNESS OF THE STEEL PIPE AT THE SECTION WHERE USED.
- 6. DRILL AND TAP 4-1/4" DIA. HOLES EQUALLY SPACED FOR AIR-SOAP TEST. BEFORE WELDING, DRILL AND TAP HOLES. PLUG WELD HOLES AFTER SUCCESSFUL COMPLETION OF JOINT TEST.
- 7. FIELD APPLY HEAT SHRINK SLEEVE WITH A MINIMUM OVERLAP OF 4" OVER POLYURETHANE COATING.


WELDED BUTT STRAP JOINT DETAIL POLYURETHANE COATED STEEL PIPE Scale: NTS.

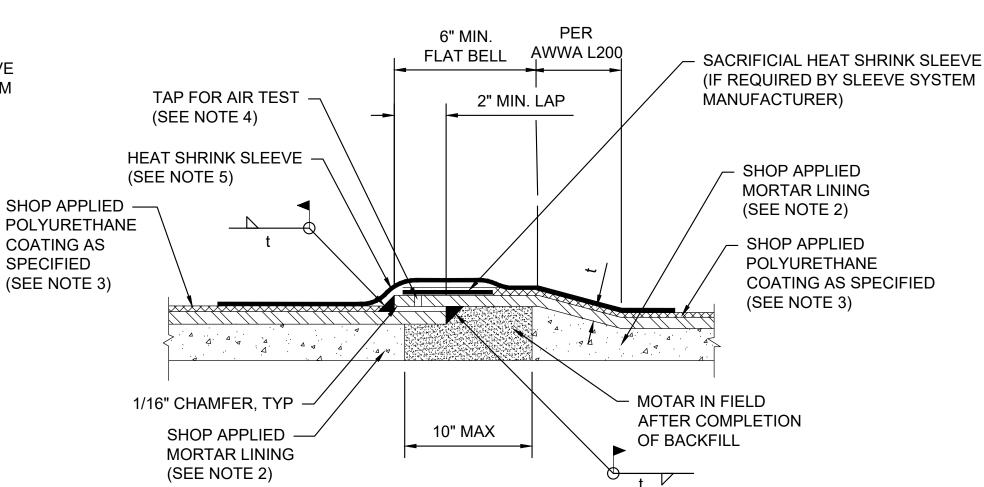



NOTES:

- 2" MIN FROM BELL TANGENT TO WELD.
- 2. HOLD BACK SHOP APPLIED MORTAR LINING MIN. 6 INCHES ON BELL END AND 2 INCHES ON
- HOLD BACK SHOP APPLIED POLYURETHANE COATING MIN. 5 INCHES ON BELL END AND 4 INCHES ON SPIGOT END
- 4. DRILL AND TAP 4- 1/4" DIA. HOLES EQUALLY SPACED FOR AIR-SOAP TEST. BEFORE WELDING, DRILL AND TAP HOLES. PLUG WELD HOLES AFTER SUCCESSFUL COMPLETION OF JOINT TEST.
- 5. FIELD APPLY HEAT SHRINK SLEEVE WITH A MINIMUM OVERLAP OF 4" OVER POLYURETHANE
- 6. "t" INDICATES THE THICKNESS OF THE STEEL PIPE AT THE SECTION WHERE USED.


DOUBLE WELD LAP JOINT DETAIL POLYURETHANE COATED STEEL PIPE Scale: NTS.

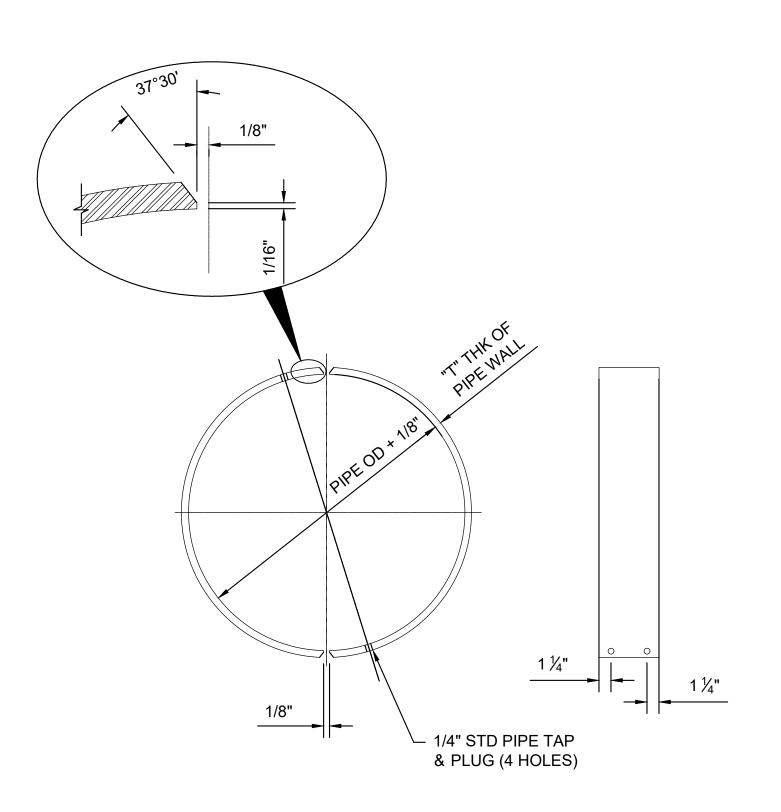

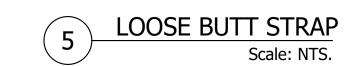

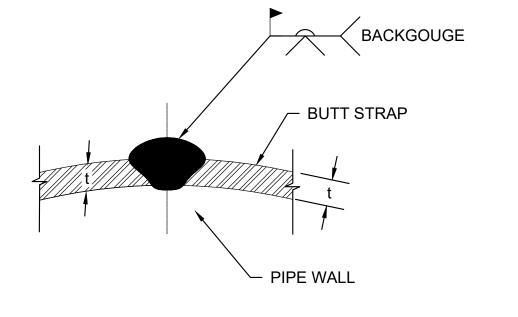

LONGITUDINAL WELD - BUTT STRAP Scale: NTS.

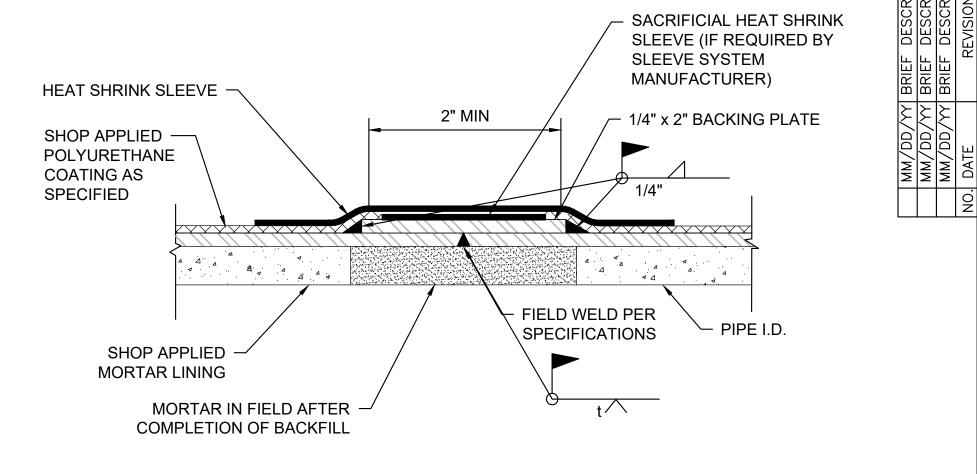

BUTT WELD JOINT DETAIL POLYURETHANE COATED STEEL PIPE Scale: NTS.



Program Manager **DANNENBĂUN**

INTERIM REVIEW ONLY

Company Name Telephone No. **Texas Firm No.**

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CONTRACT SEGMENT A1/2


STEEL PIPE DETAILS (SHEET 1 OF 2)


NOTE: CITY SIGNATURES VALID FOR ONE YEAR ONLY AFTER DATE OF SIGNATURES

CITY OF HOUSTON

HOUSTON PUBLIC WORKS STORM WATER QUALITY **FACILITIES** WASTE WATER STORM WATER TRAFFIC & TRANSPORTATION/ STREET & BRIDGE DRAWING NO. HORIZ: NTS D-02 VERT: NTS

SHEET NO. XX OF XXX DRAWING SCALE FOR CITY OF HOUSTON USE ONLY

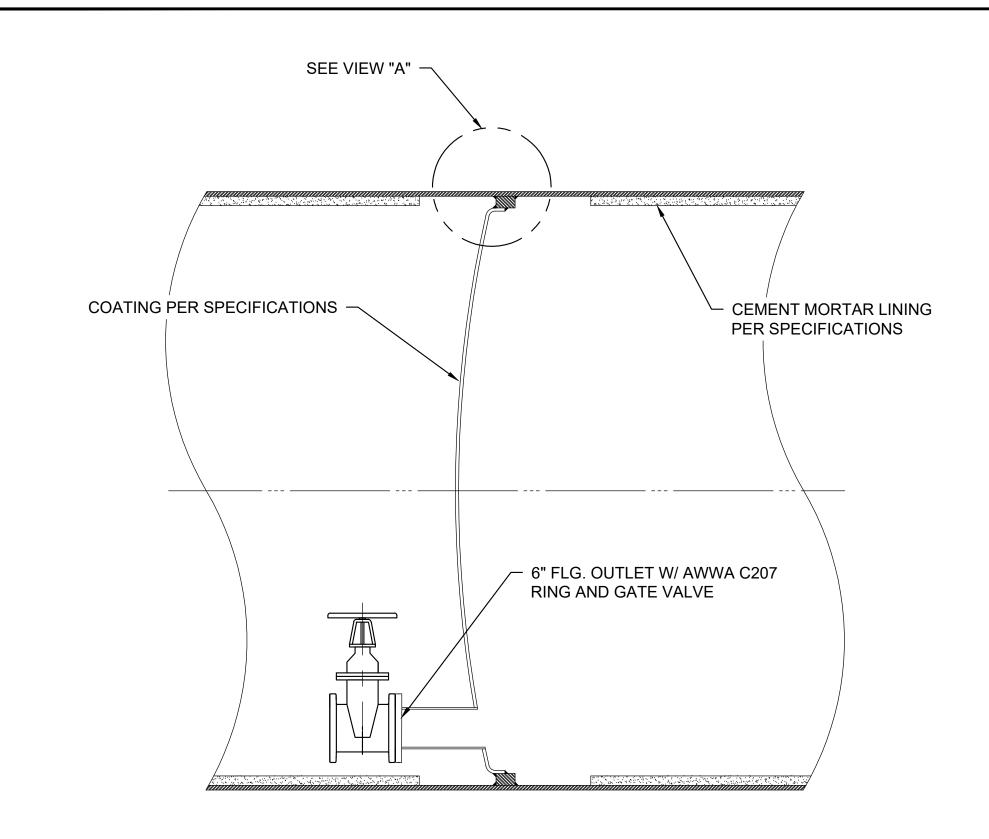

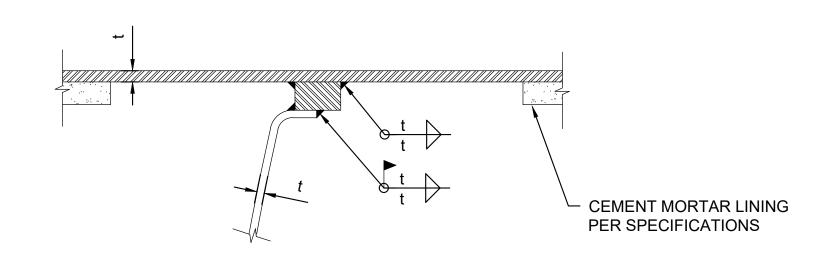


- VIEW A
Scale: N.T.S

INTERNAL ELLIPICAL DISHED HEAD PLUG DETAIL POLYURETHANE COATED STEEL PIPE

Scale: N.T.S


NOTES:

- DISHED HEAD PLUG TO BE INSTALLED AT LOCATION WHERE AIR CAN BE EXPELLED THROUGH AIR VALVE OR ACCESS MANHOLE DURING FILLING.
- 2. DISHED HEAD PLUGS SHALL BE CAPABLE OF WITHSTANDING THE HYDROSTATIC TEST PRESSURE FROM EITHER SIDE, WITH THE OPPOSITE SIDE EMPTY OF WATER
- 3. t = STEEL PIPE WALL THICKNESS AND SIZE OF FILLET ATTACHMENT WELD.

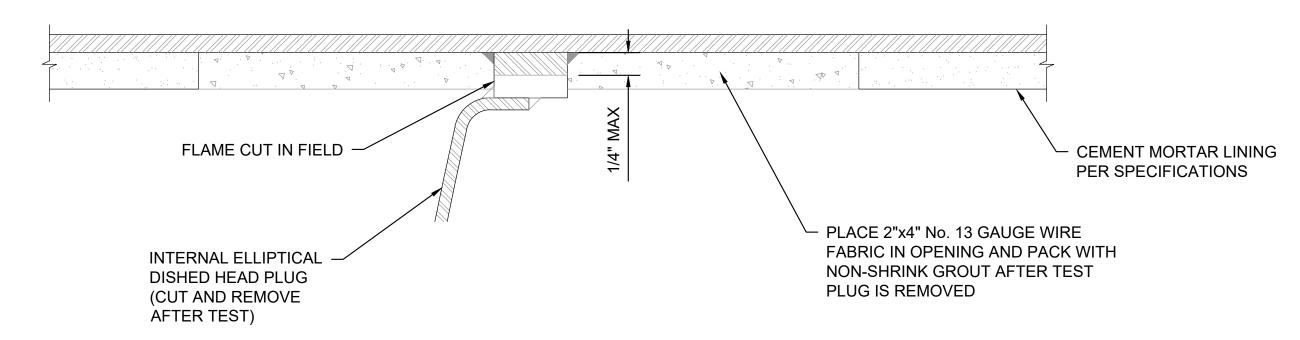

NOTE: USE CAUTION WHEN REMOVING BULK HEADS. ALL GOUGES AND SURFACE DEFECTS SHALL BE REPAIRED AS DIRECTED BY ENGINEER.

2 INTERNAL ELLIPTICAL DISHED HEAD PLUG REMOVAL
Scale: N.T.S

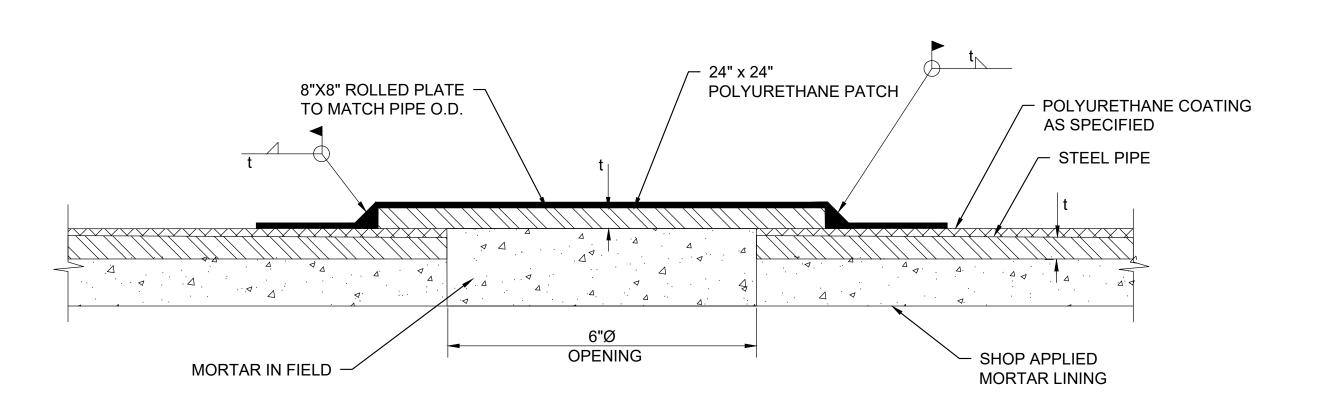

t = 0.1875" OUTLET ID = 7.00" (STEEL) OUTLET OD = 7.25" (STEEL)

NOTES:

- PASS THROUGH FOR WELD LEADS MAY BE SPACED NO CLOSER THAN 500' AND NO CLOSER THAN 500' FROM AIR VALVE OR ACCESS MANHOLE OUTLETS.
- 2. PASS-THROUGH TO BE DESIGNED PER AWWA M-11.
- 3. ROLLED PLATE SHALL BE CENTERED OVER PASS-THROUGH OUTLET AND BE A MINIMUM OF $\frac{1}{2}$ " THICK OR EQUAL TO PIPE WALL THICKNESS, WHICHEVER IS GREATER.



Program Manager

DANNENBAUM

ENGINEERING CORPORATION

Company Name

Address
Telephone No.
Texas Firm No.

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| John D. Doe | Engineer | XXXX | Registration Number | 08/31/2019

Engineer of Record

CONTRACT SEGMENT A1/2

STEEL PIPE DETAILS (SHEET 2 OF 2)

NOTE: CITY SIGNATURES VALID FOR ONE YEAR ONLY AFTER DATE OF SIGNATURES

CITY OF HOUSTON HOUSTON PUBLIC WORKS

WATER

WASTE WATER

FACILITIES

TRAFFIC & TRANSPORTATION/
STREET & BRIDGE

DRAWING NO.

D-03

SHEET NO. XX OF XXX

DRAWING NO.

HORIZ: NTS.


VERT: NTS.

DRAWING SCALE

FOR CITY OF HOUSTON USE ONLY

WHCRWA NFBWA
SURFACE WATER
SUPPLY PROJECT

:

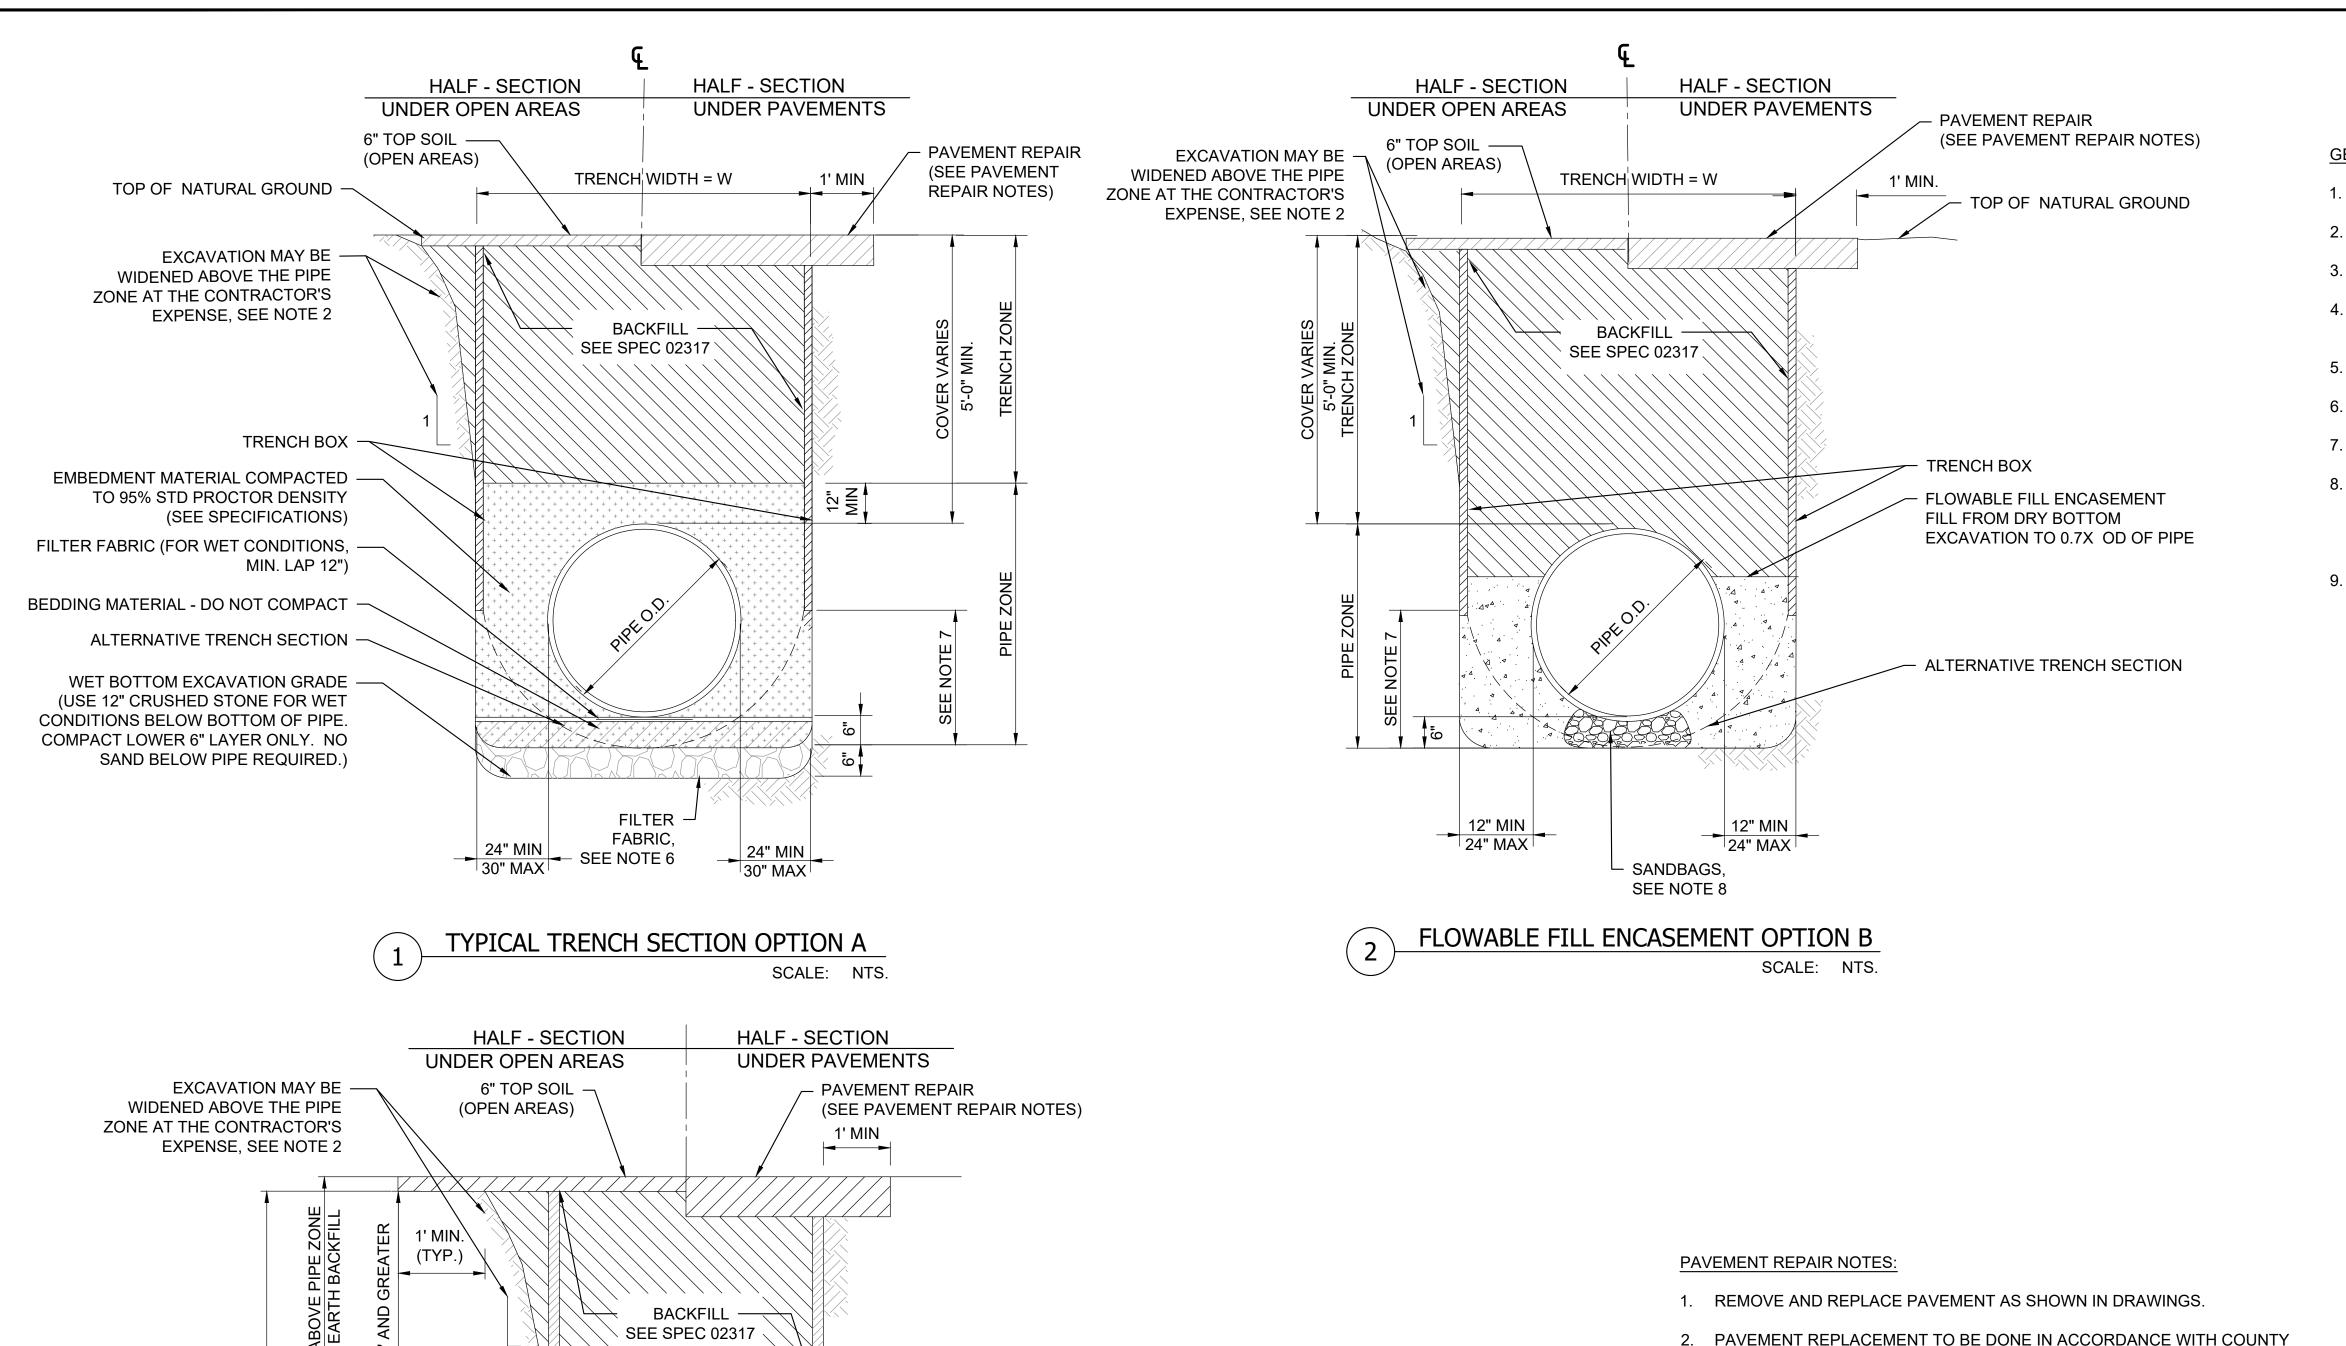

TRENCH BOX

SPRING LINE

24" MIN.

30" MAX.

- COMPACT TO 95% STD.

WET CONDITIONS, MIN. LAP 12")

ALTERNATIVE TRENCH SECTION

SAND BELOW PIPE REQUIRED.).

WET BOTTOM EXCAVATION GRADE

(USE 12" CRUSHED STONE FOR WET

CONDITIONS BELOW BOTTOM OF PIPE.

COMPACT LOWER 6" LAYER ONLY. NO

- DRY BOTTOM EXCAVATION

BEDDING MATERIAL - DO NOT COMPACT

- FILTER FABRIC (FOR

- 1. REMOVE AND REPLACE PAVEMENT AS SHOWN IN DRAWINGS.
- 2. PAVEMENT REPLACEMENT TO BE DONE IN ACCORDANCE WITH COUNTY OR CITY STANDARDS.
- NEW CONCRETE PAVEMENTS TO BE SAME THICKNESS AS EXISTING, UNLESS OTHERWISE DIRECTED BY THE WHCRWA.
- 4. STREETS OR DRIVEWAYS SHALL BE REPAIRED OR REPLACED USING HIGH EARLY STRENGTH CONCRETE AS INDICATED ON DRAWINGS, ACCORDING TO PAVEMENT REPLACEMENT SCHEDULE WHERE PROVIDED, OR AS DIRECTED BY WHCRWA.
- 5. ANY REMOVAL AND REPLACEMENT OF PAVEMENT NOT IDENTIFIED ON THE DRAWINGS SHALL BE COORDINATED WITH THE ENGINEER AND THE WHCRWA.
- WHEN CURB IS REMOVED AND REPLACED, INSTALL 1 FOOT STRIP OF SOD GRASS BEHIND CURB TO PREVENT EROSION UNTIL GRASS IS ESTABLISHED.
- ROADWAY EXCAVATION, SITE GRADING, AND HYDROMULCH SEEDING OR SODDING WITHIN R.O.W. AND/OR LIMITS OF CONSTRUCTION SHALL BE IN ACCORDANCE WITH CONSTRUCTION SPECIFICATIONS.

GENERAL NOTE:

- 1. BACKFILL TO NATURAL GROUND SURFACE UNLESS OTHERWISE SHOWN ON PLAN AND PROFILE DRAWINGS
- 2. SEE TRENCH SAFETY SYSTEM SPECIFICATION FOR MAXIMUM
- ALLOWABLE SLOPES AND TRENCH BOX REQUIREMENTS. FOR WET BOTTOM EXCAVATION LIMITS OF CRUSHED STONE, EXTEND AS
- SHOWN. PROVIDE FILTER FABRIC AROUND CRUSHED STONE. 4. PIPE EMBEDMENT ZONE MUST BE FILLED AND RECOMPACTED TO
- PROPER DENSITIES AFTER MOVING SUPPORT SYSTEM FORWARD (APPLIES TO DETAILS 1 AND 3). USE FILTER FABRIC OR POLYETHYLENE WRAP AS A BOND BREAKER
- BETWEEN CEMENT STABILIZED SAND AND PIPE. 6. REFER TO SPEC 02317 FOR GEOTEXTILE REQUIREMENTS AROUND
- EMBEDMENT. 7. ADJUST HEIGHT OF UNSUPPORTED TRENCH AS NEEDED FOR SAFE
- CONDITIONS. PROVIDE SANDBAGS FOR FLOWABLE FILL ENCASEMENT TO SUPPORT PIPE TO CORRECT GRADE ABOVE TRENCH BOTTOM. USE ONE SUPPORT

5 FEET FROM EACH END AND AT 10 FEET O.C. FOR THE MIDDLE. FOR

PIPE FURNISHED IN 12 FOOT LENGTHS, USE ONE SUPPORT 3 FEET FROM

EACH END. 9. IN WETLAND AREAS WITH OPEN-CUT CONSTRUCTION, STRIP AND STOCKPILE 6" OF TOPSOIL. RESTORE TOPSOIL AFTER BACKFILLING TO MATCH PRE-CONSTRUCTION GRADE. SEE PLAN AND PROFILE SHEETS FOR AREAS WITH DELINEATED WETLANDS.



Program Manager **DANNENBĂUN**

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08/31/2019

Engineer of Record

CONTRACT SEGMENT A1/2

EXCAVATION BEDDING AND BACKFILL DETAIL

NOTE: CITY SIGNATURES VALID FOR ONE YEAR ONLY AFTER DATE OF SIGNATURES

CITY OF HOUSTON HOUSTON PUBLIC WORKS

WATER STORM WATER QUALITY **FACILITIES** WASTE WATER STORM WATER TRAFFIC & TRANSPORTATION/ STREET & BRIDGE

DRAWING NO. HORIZ: NTS. D-04 VERT: NTS. SHEET NO. XX OF XXX DRAWING SCALE

FOR CITY OF HOUSTON USE ONLY

EXCAVATION & BACKFILL DETAIL SCALE: NTS. (FOR WATER MAIN WITH HEIGHT OF COVER GREATER THAN 16')

FILTER

FABRIC, SEE NOTE 6

BACKFILL **SEE SPEC 02317**


DETAIL 3 APPLICABLE IN THE FOLLOWING AREAS: - WATER MAIN WITH HEIGHT OF COVER GREATER THAN 16'


- TUNNEL SHAFT LIMITS


24" MIN.

30" MAX.

- PPCA LIMITS

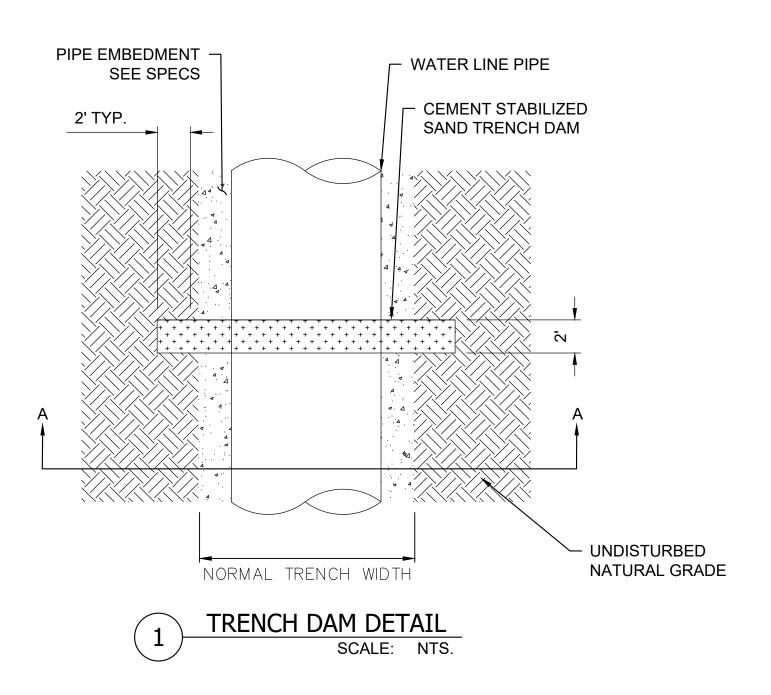

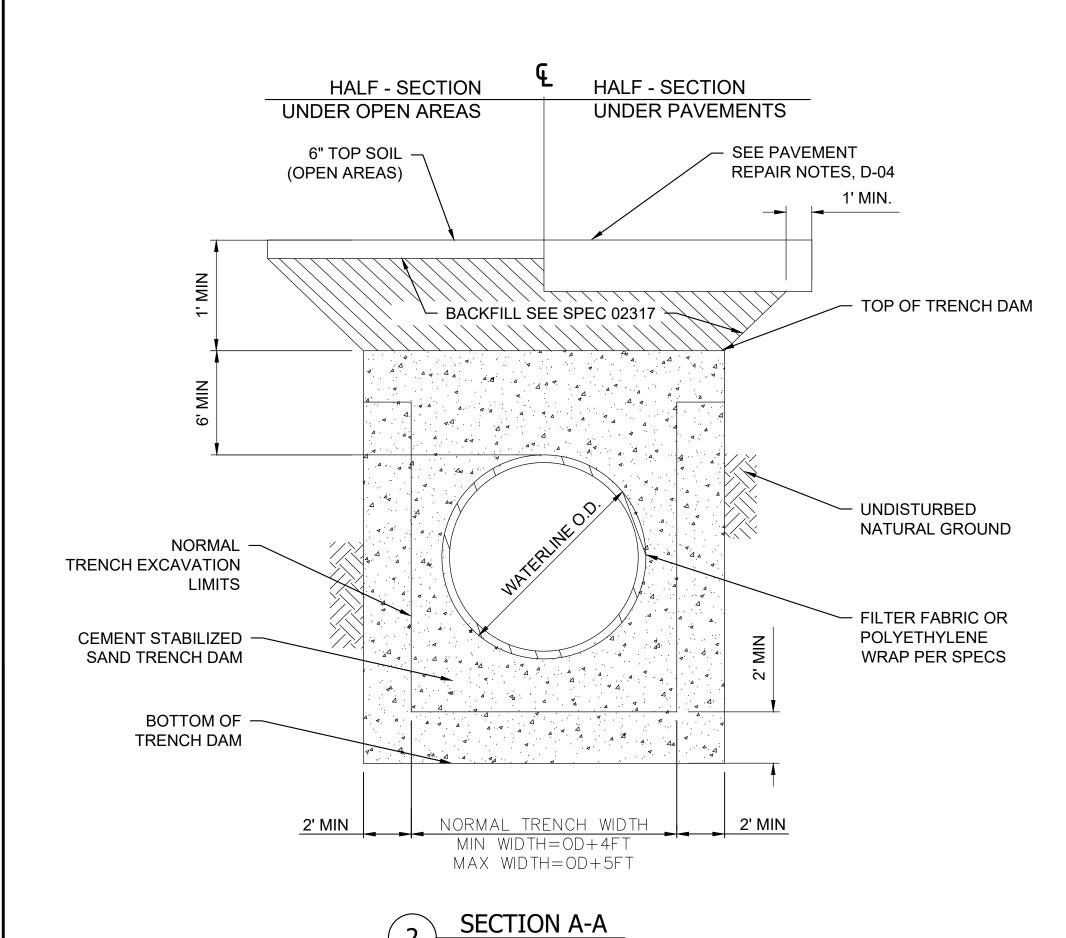

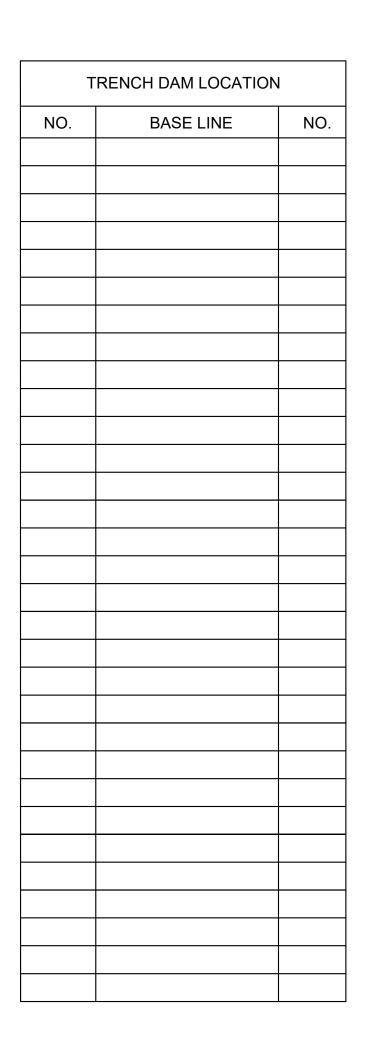

GENERAL NOTES:

- 1. REFER TO SPEC 02317 FOR INSTALLATION REQUIREMENTS.
- 2. KEY CONCRETE TRENCH DAM MINIMUM OF 2-FT INTO TRENCH BOTTOM AND WALLS.
- 3. TRENCH DAM MAY BE FORMED OR UNFORMED. ACTUAL SHAPE OF CONCRETE TRENCH DAM CROSS SECTION MAY BE DETERMINED BY CONTRACTOR IN FIELD, MEETING 2-FT MINIMUM THICKNESS AND 2-FT KEY DEPTH REQUIREMENTS.
- 4. TRENCH DAM SHALL BE PLACED AT LEAST 5-FT AWAY FROM ANY PIPELINE STRUCTURE (EACH SIDE). SEE SECTION 02317 FOR OTHER REQUIREMENTS.
- 5. USE FILTER FABRIC OR POLYETHYLENE WRAP AS A BOND BREAKER BETWEEN CEMENT STABILIZED SAND AND PIPE.
- 6. EXTEND TRENCH DAM 6-FT MIN. ABOVE TOP OF SURROUNDING GRANULAR SOIL LAYERS OR TOP OF GRANULAR EMBEDMENT MATERIAL, WHICHEVER IS HIGHEST.

WHCRWA NFBWA
SURFACE WATER
SUPPLY PROJECT

Program Manager

DANNENBAUM

Company Name

Address Telephone No. Texas Firm No.

______08/31/2019

Engineer of Record
Texas Registered Engineering Firm F-#XXX

XXXXX

CONTRACT SEGMENT A1/2

TRENCH DAM DETAILS

NOTE: CITY SIGNATURES VALID FOR ONE YEAR ONLY AFTER DATE OF SIGNATURES

CITY OF HOUSTON
HOUSTON PUBLIC WORKS

STORM WATER QUALITY

FACILITIES

STORM WATER TRAFFIC & TRANSPORTATION/STREET & BRIDGE

DRAWING NO.

D-05

HORIZ:NTS.

VERT: NTS.

SHEET NO. XX OF XXX DRAWING SCALE


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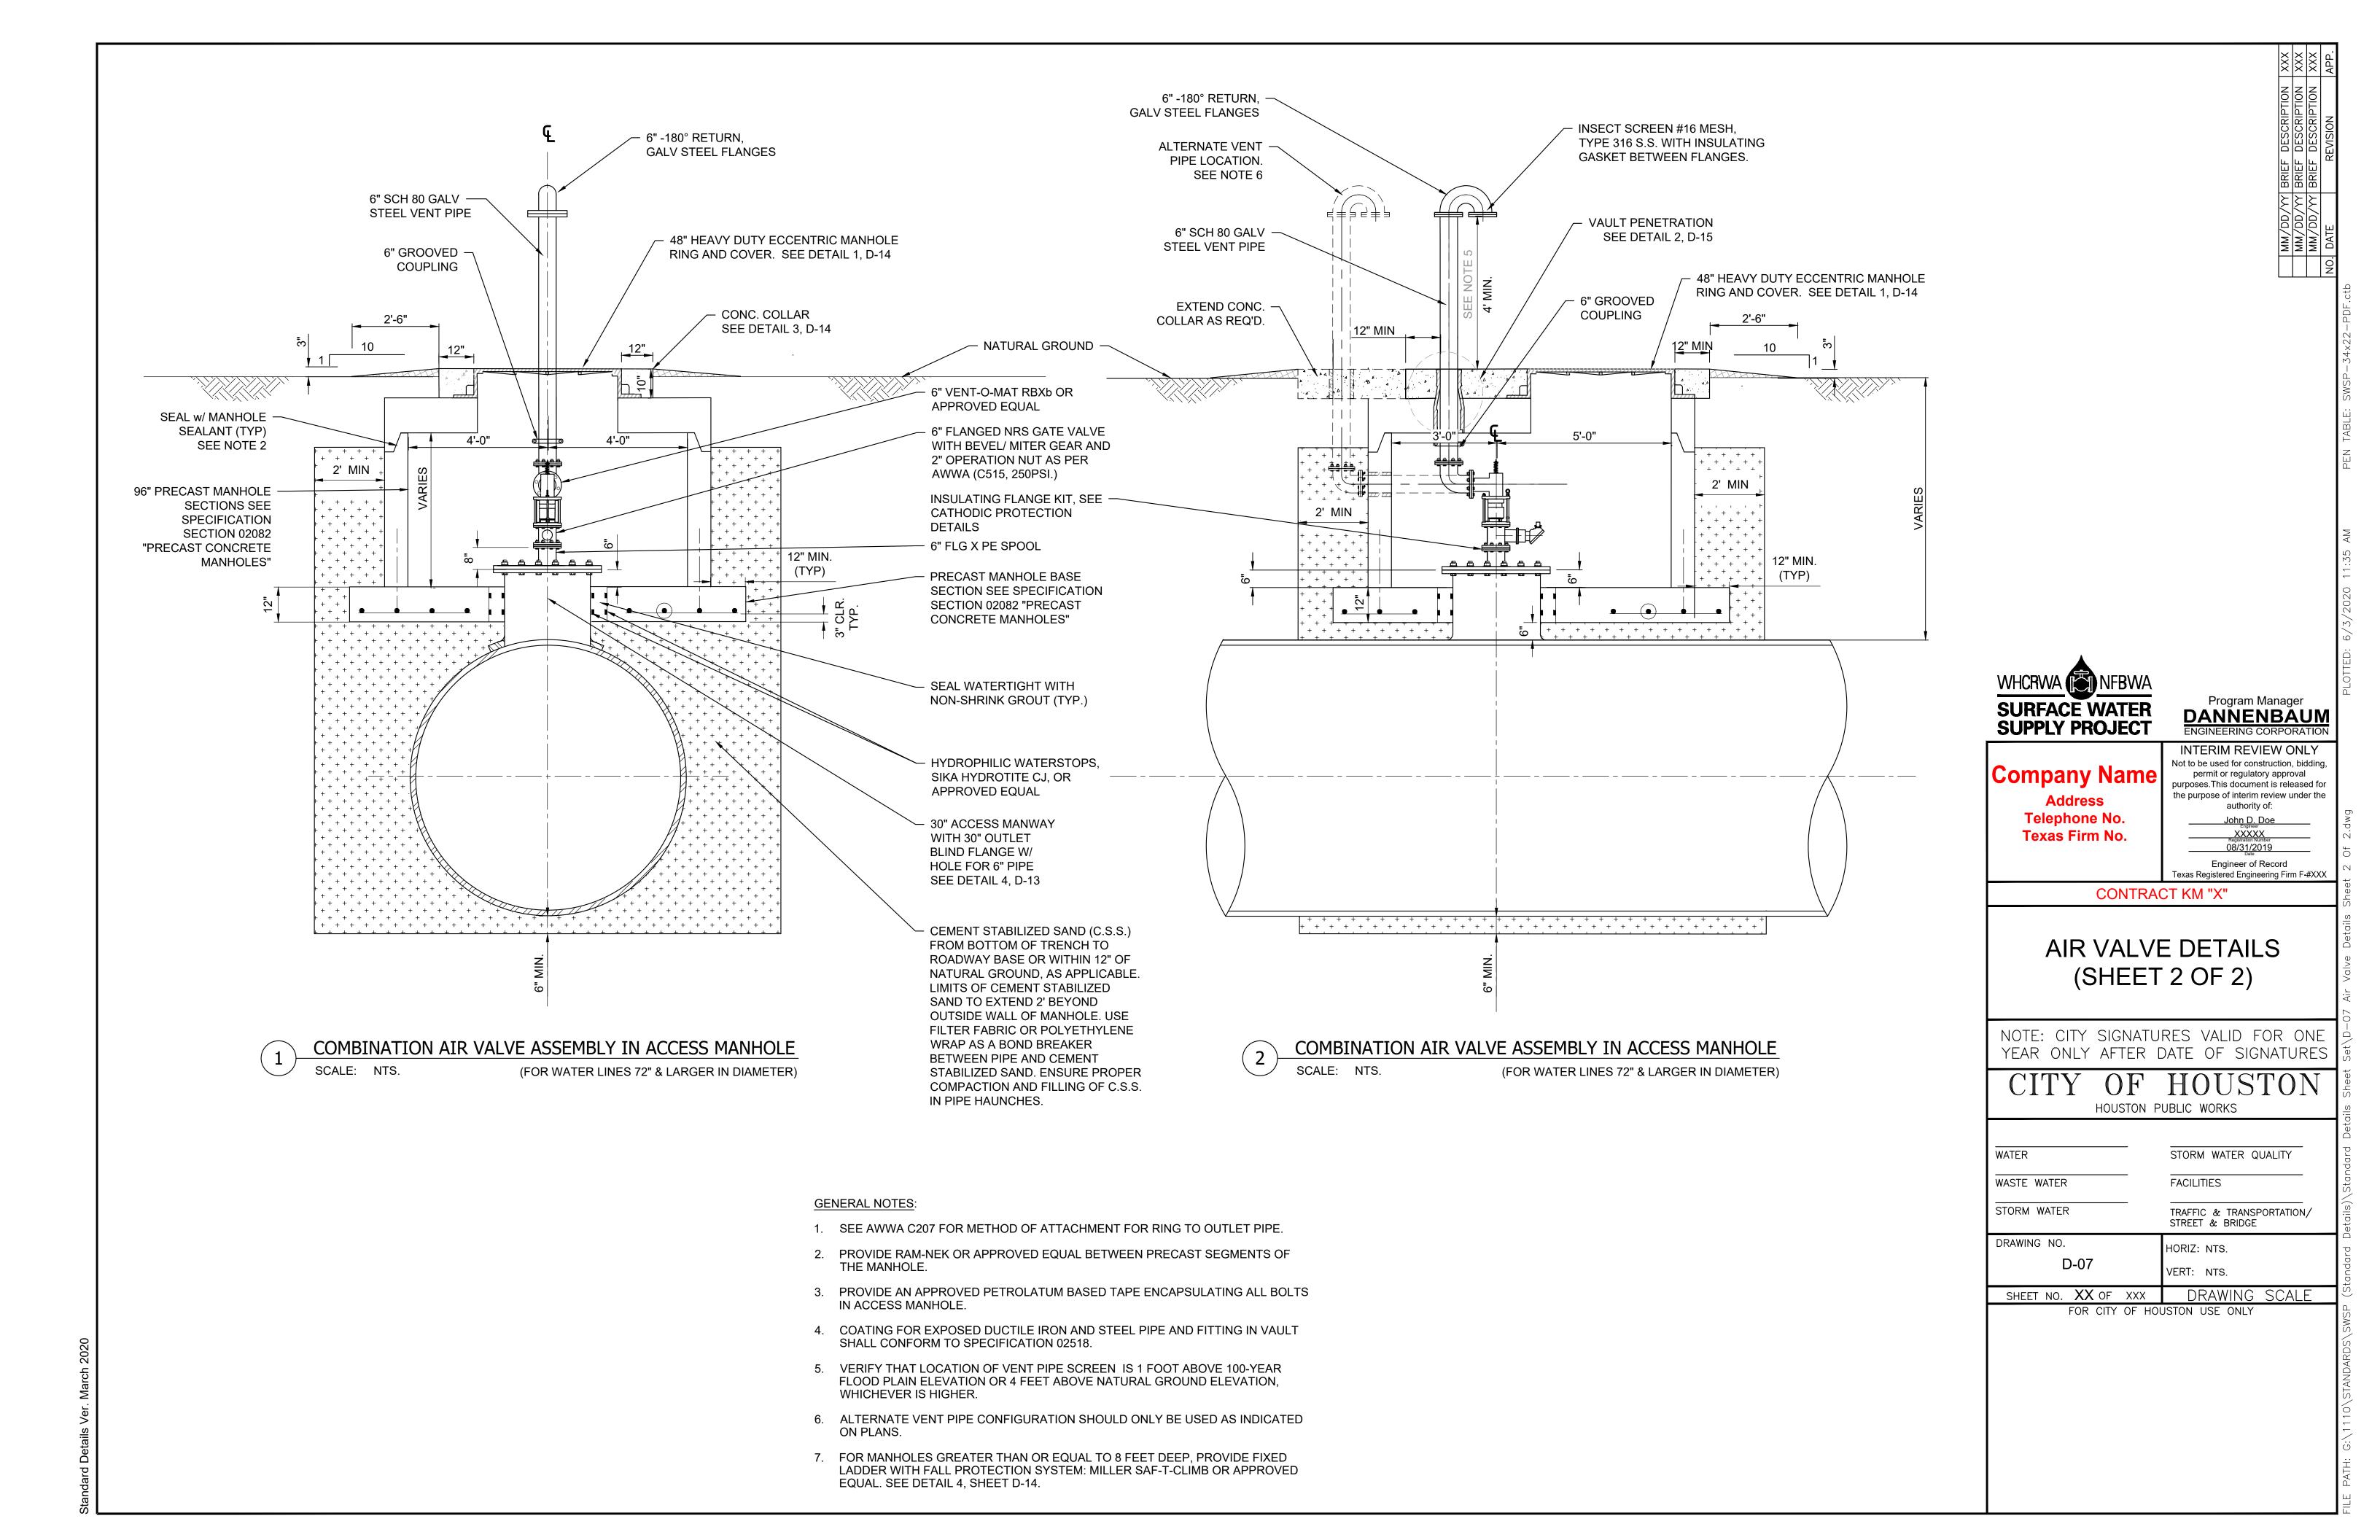
standard Details Ver. March 2020


FOR CITY OF HOUS

WATER

WASTE WATER



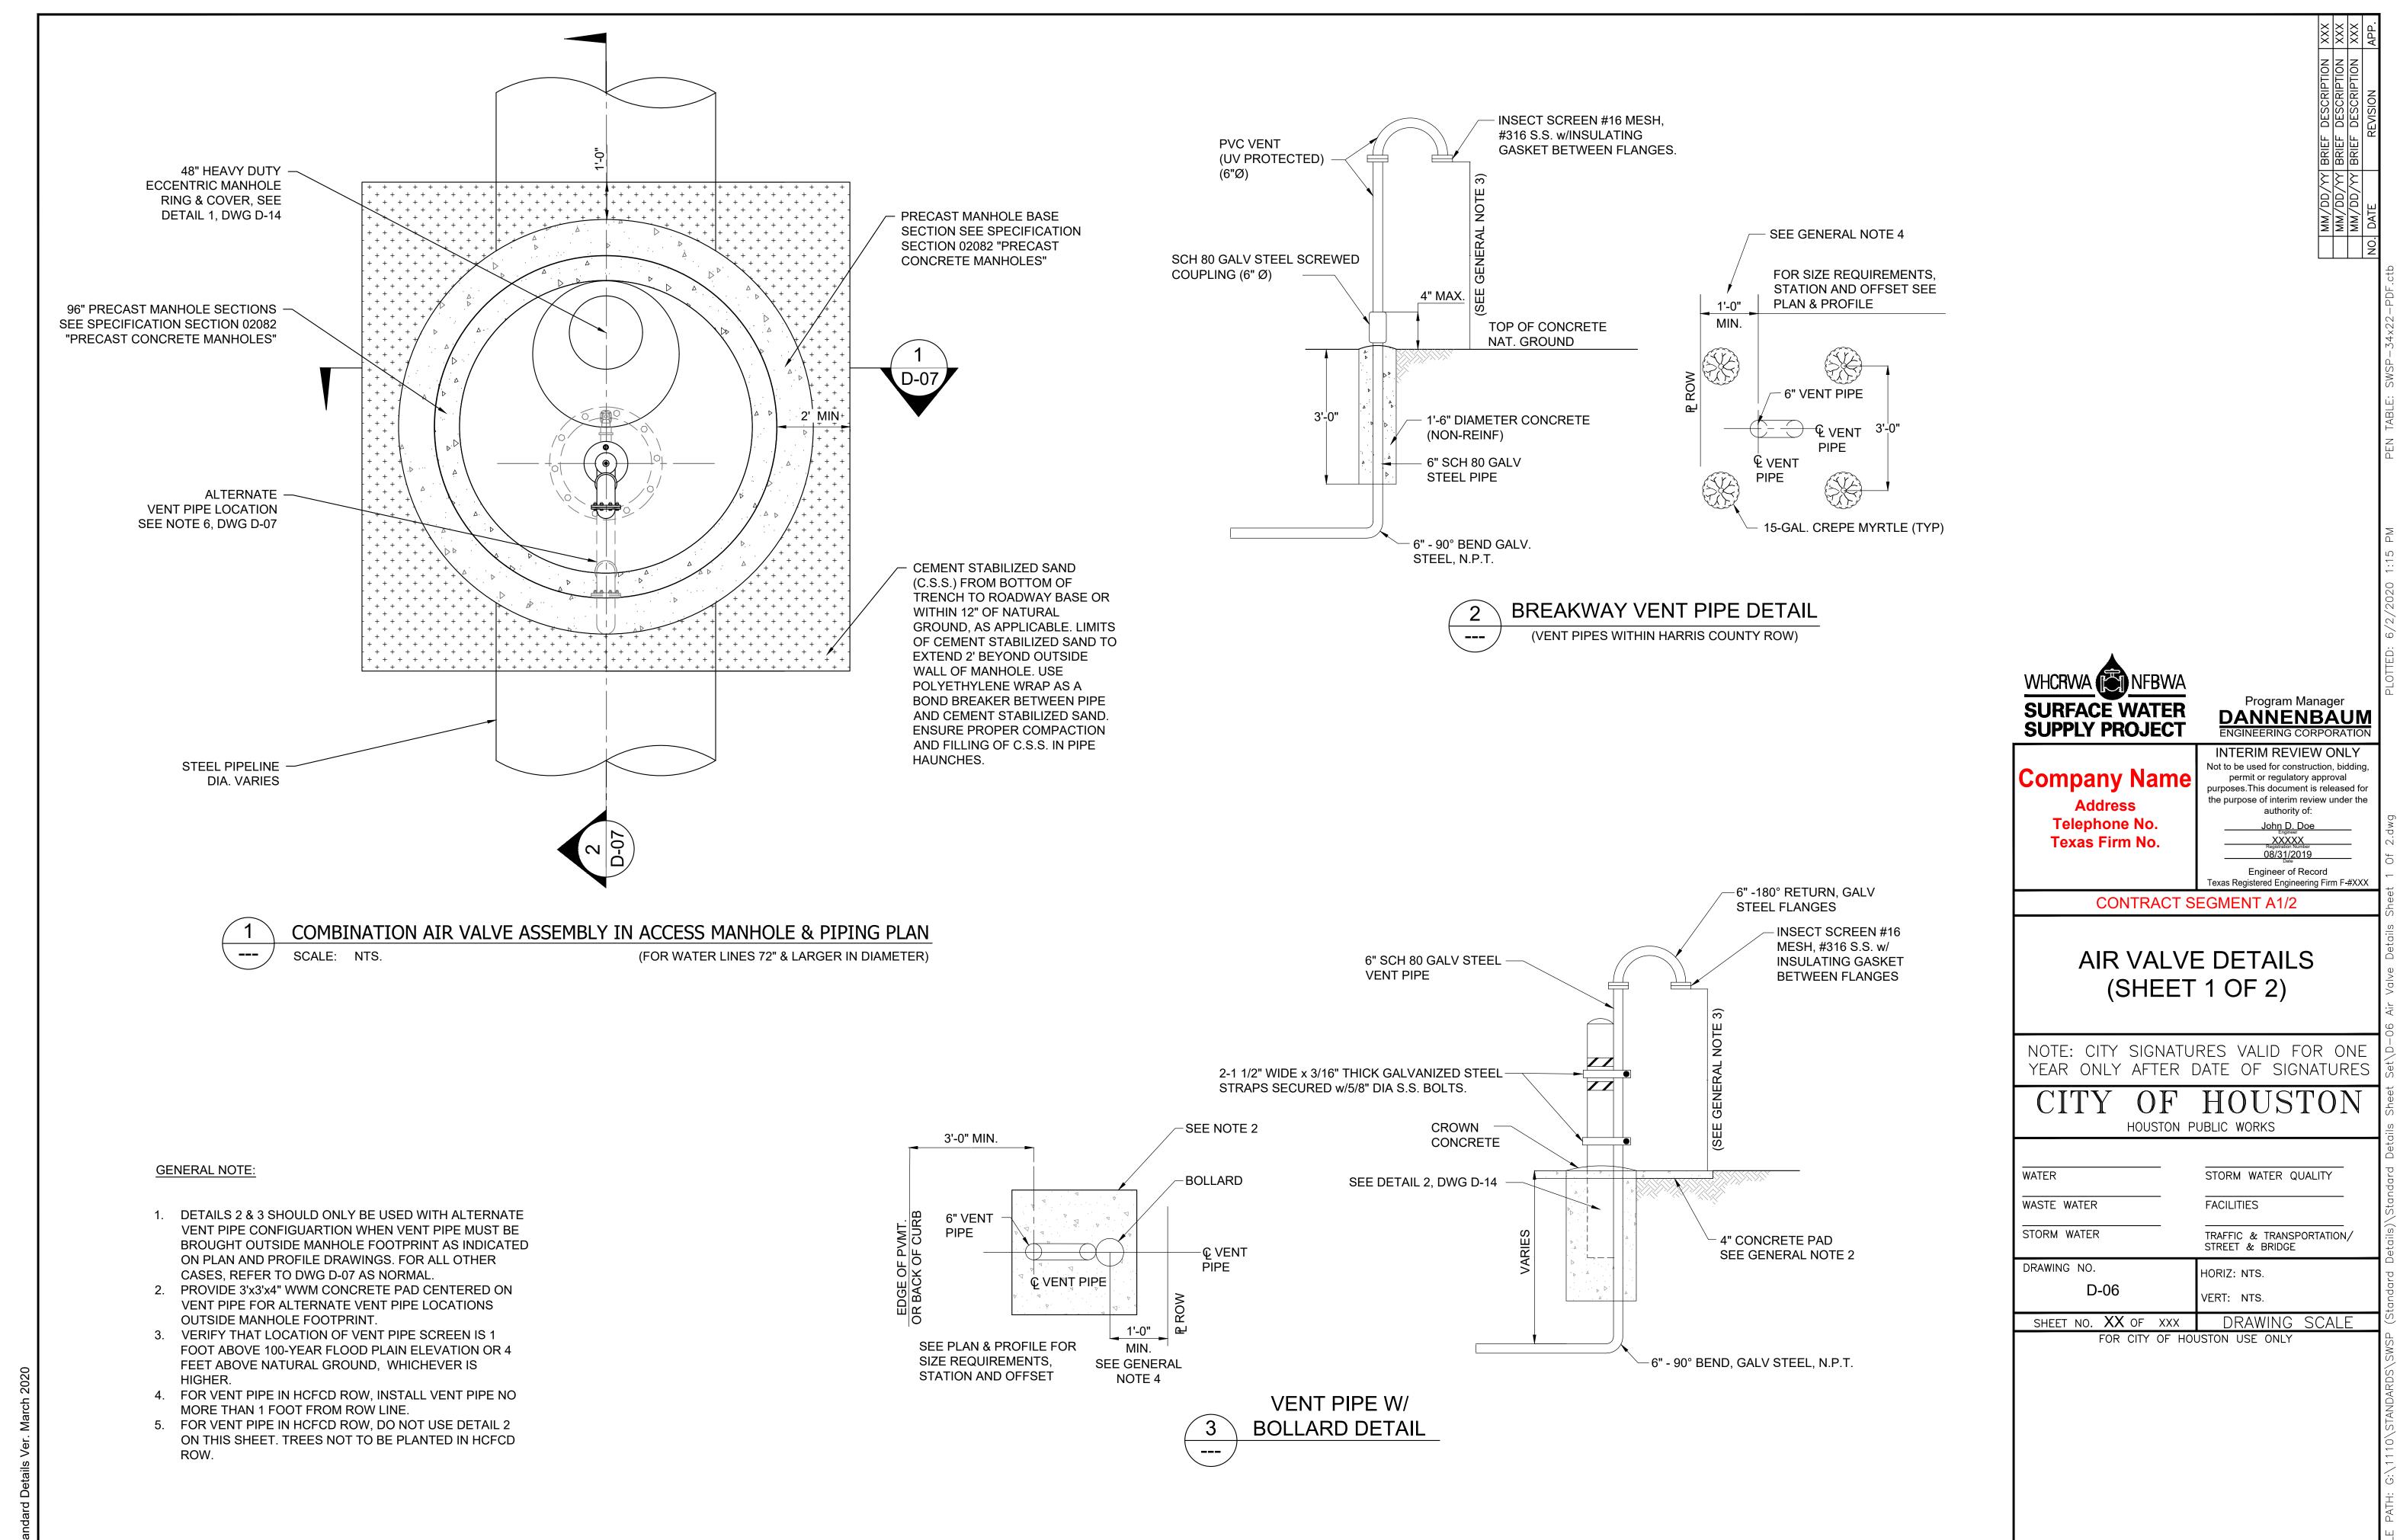

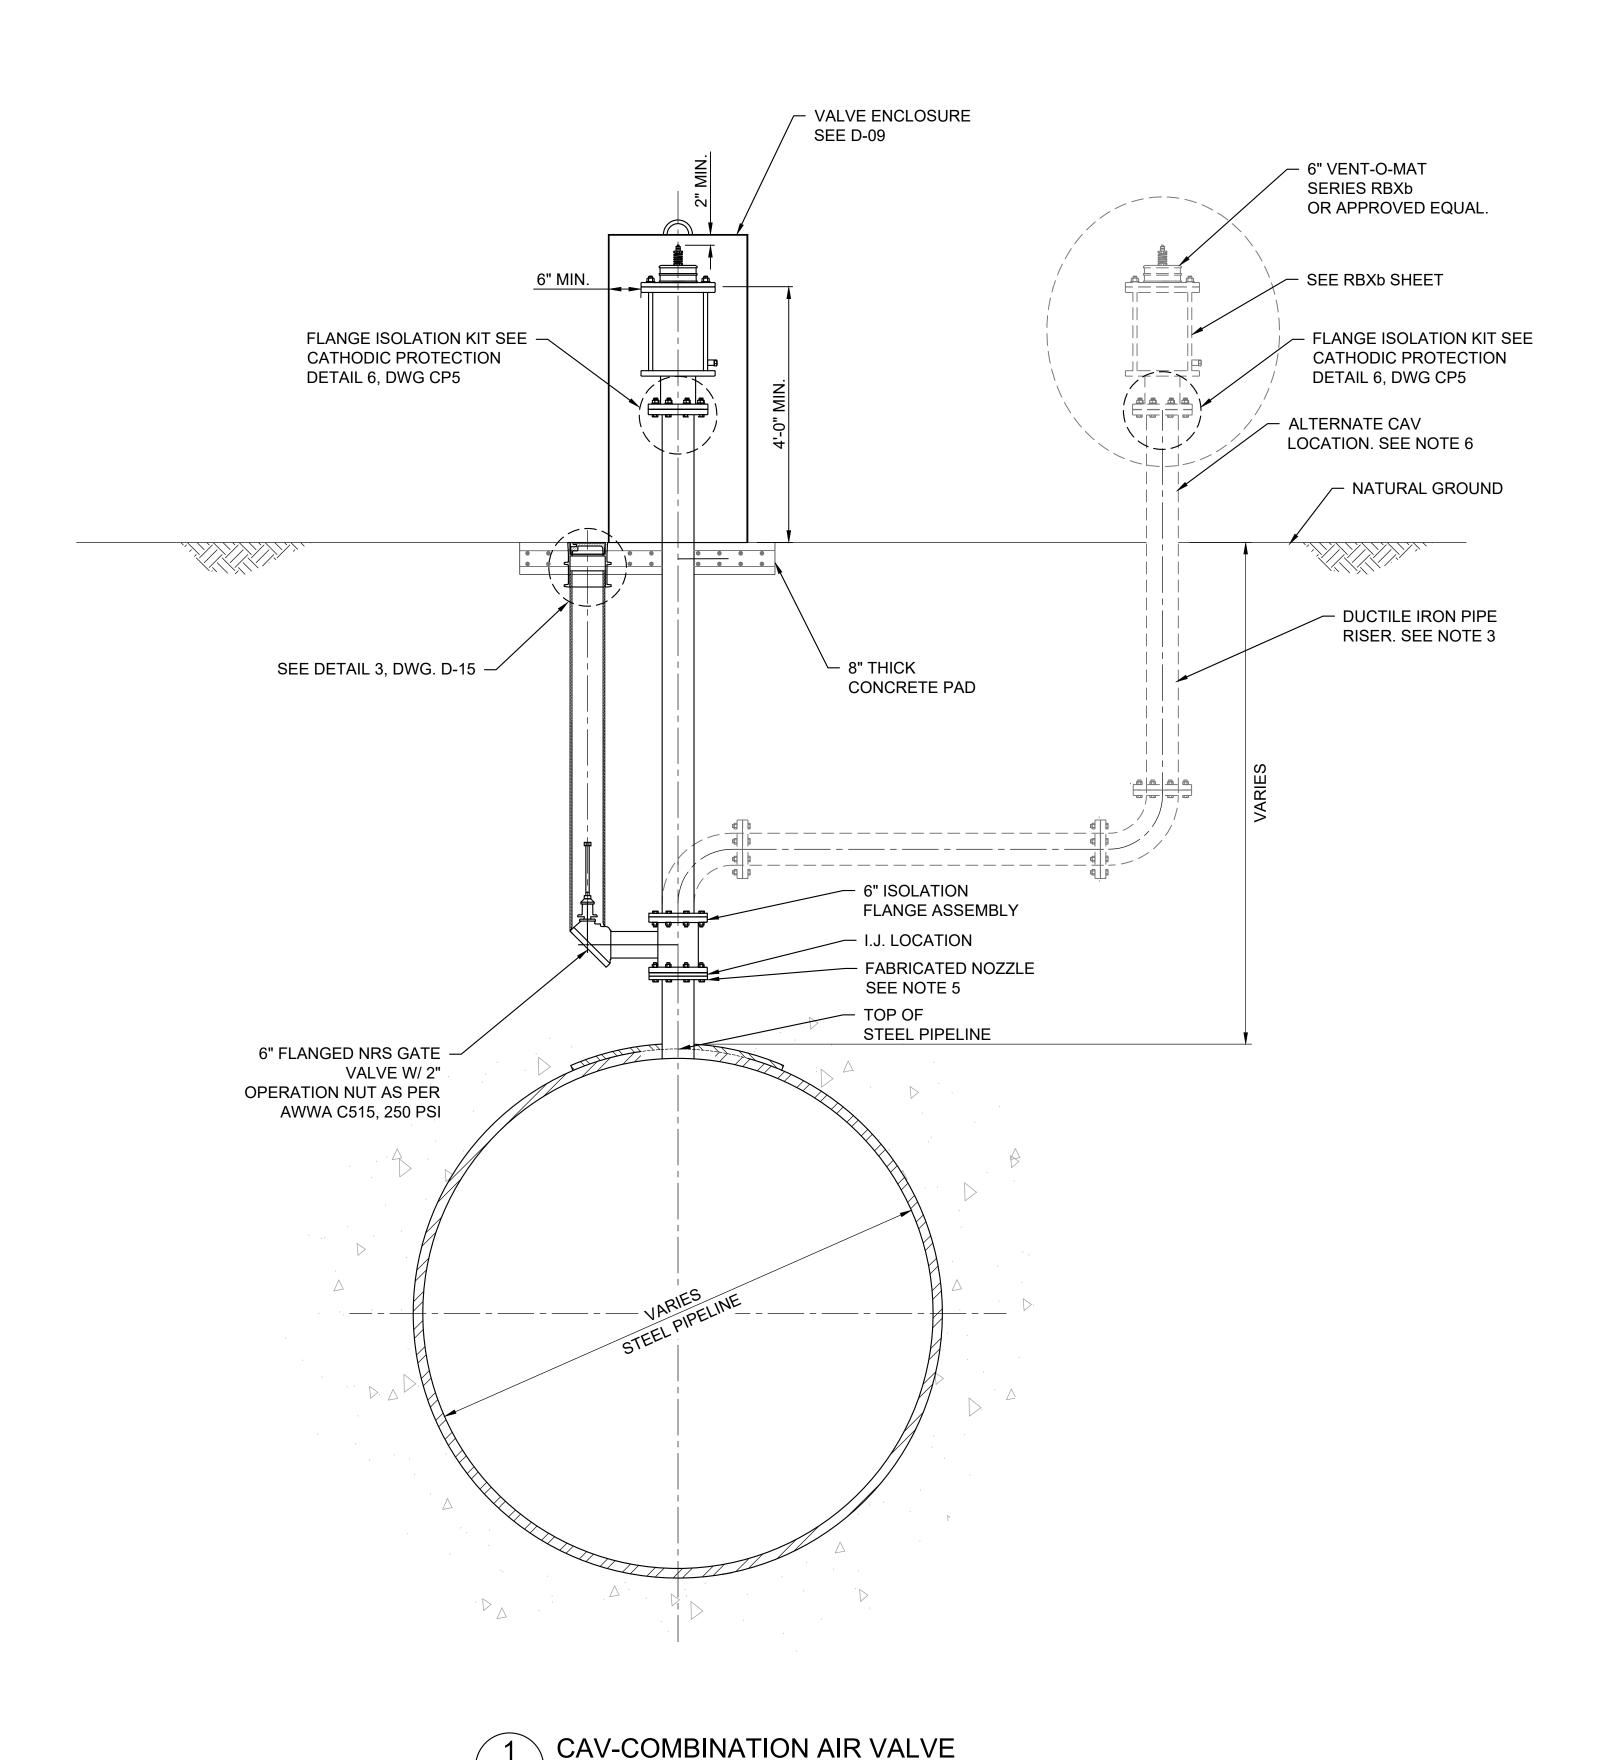

(FOR WATER LINES 72" & LARGER IN DIAMETER)

SCALE: N.T.S.

VALVE BOX COVER SEE DETAIL 4, D-15



GENERAL NOTES:

- 1. REFER TO PROFILE FOR SPECIFIC DEPTHS.
- 2. SEE PLAN AND PROFILE SHEETS FOR VALVE SIZE AND STATION LOCATIONS.
- 3. PIPE RISER SHALL BE INSTALLED PLUMB UNLESS OTHERWISE SPECIFIED. REFER TO PLAN AND PROFILE SHEETS TO DETERMINE PROPER INSTALLATION.
- 4. D.I. RISERS SHALL BE WRAPPED IN POLYETHYLENE BELOW GROUND, AND PAINTED ABOVE GROUND. PROVIDE AN APPROVED PETROLATUM BASED TAPE TO ENCAPSULATE ALL BOLTS.
- 5. INSULATE FLANGE WITH FULL FACE PHENOLIC GASKET, SLEEVES AND WASHERS.
- 6. ALTERNATE CAV LOCATION TO BE USED AS SHOWN ON PLAN AND PROFILE DRAWINGS AS NECESSARY. ENCLOSURE, CONCRETE PAD AND OTHER ITEMS SHOWN IN DETAIL FOR STANDARD CAV LOCATION ARE NOT SHOWN FOR ALTERNATE CAV ALIGNMENT FOR SIMPLIFICATION PURPOSES.



Program Manager

DANNENBAUM

ENCINETEDING CORPORATION

Company Name

Address
Telephone No.

Texas Firm No.

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John D. Doe

Engineer

XXXXX

Registration Number

08/31/2019

Date

Engineer of Record
Texas Registered Engineering Fir

CONTRACT SEGMENT A1/2

ABOVE GRADE AIR VALVE DETAILS (SHEET 1 OF 2)

NOTE: CITY SIGNATURES VALID FOR ONE YEAR ONLY AFTER DATE OF SIGNATURES

CITY OF HOUSTON

HOUSTON PUBLIC WORKS

FACILITIES

STREET & BRIDGE

TRAFFIC & TRANSPORTATION/

WATER STORM WATER QUALITY

STORM WATER

WASTE WATER


D-08 HORIZ:NTS.


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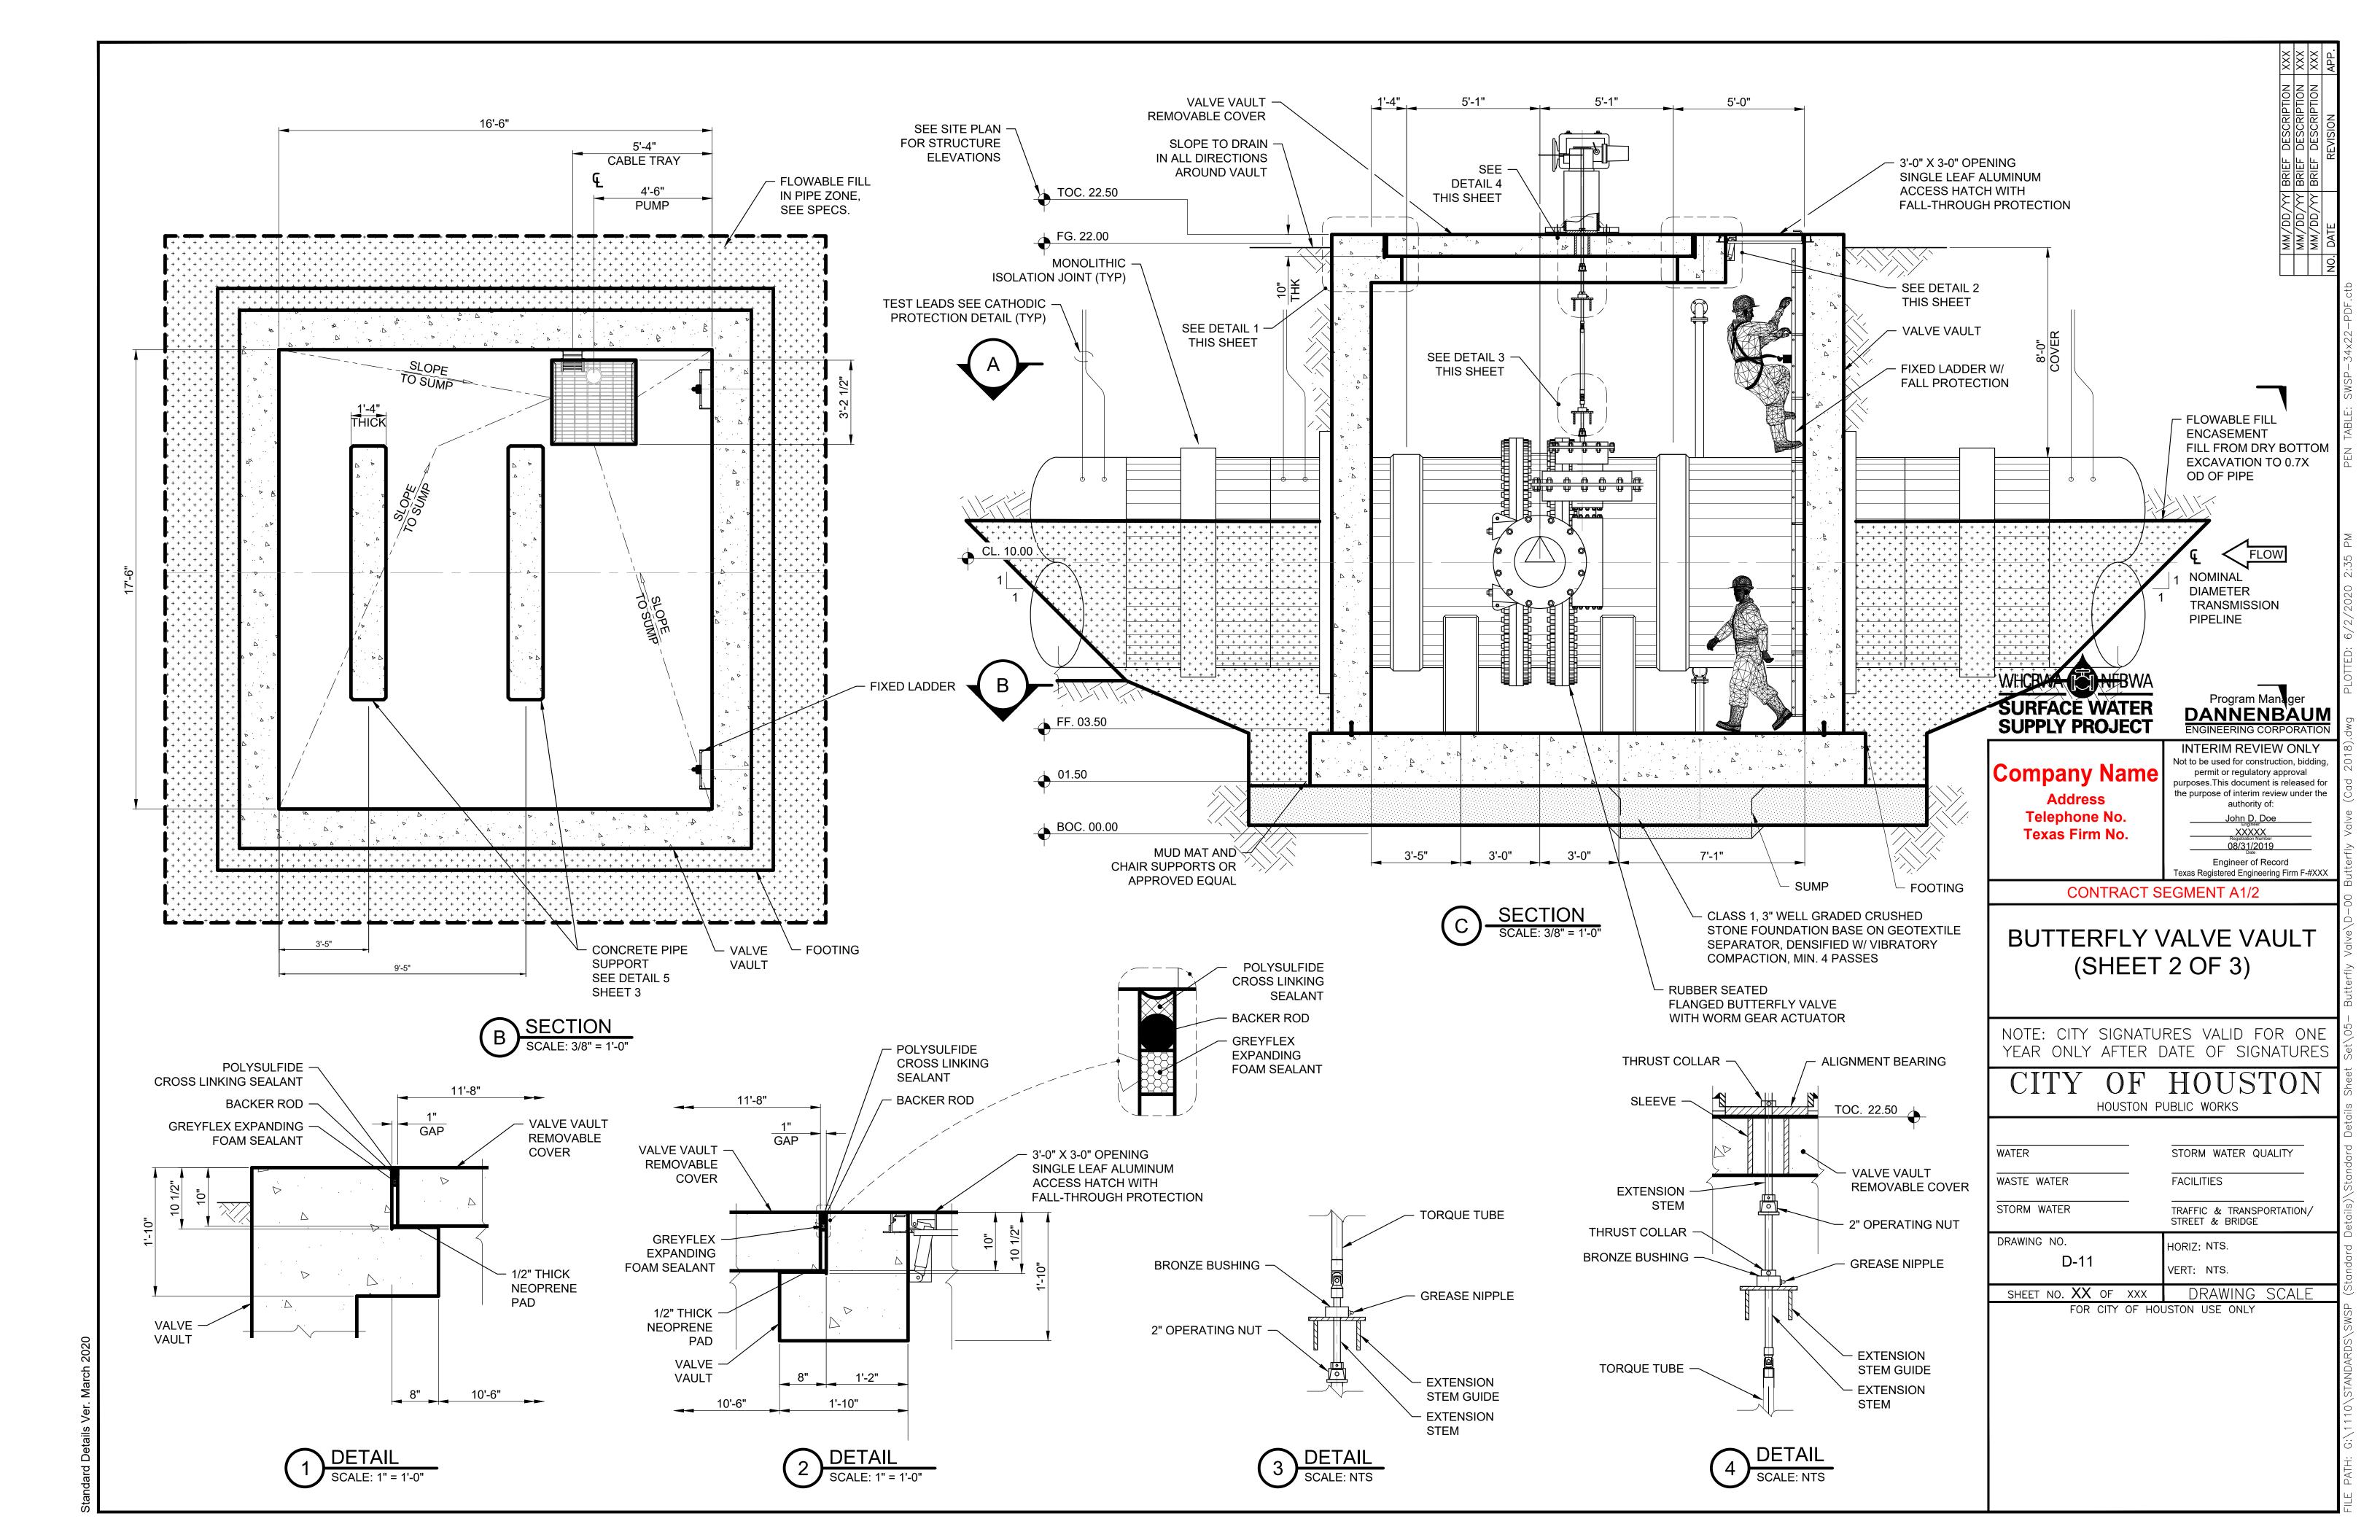
SHEET NO. XX OF XXX DRAWING SCALE


FOR CITY OF HOUSTON USE ONLY


ndard Details Ver. March 2020




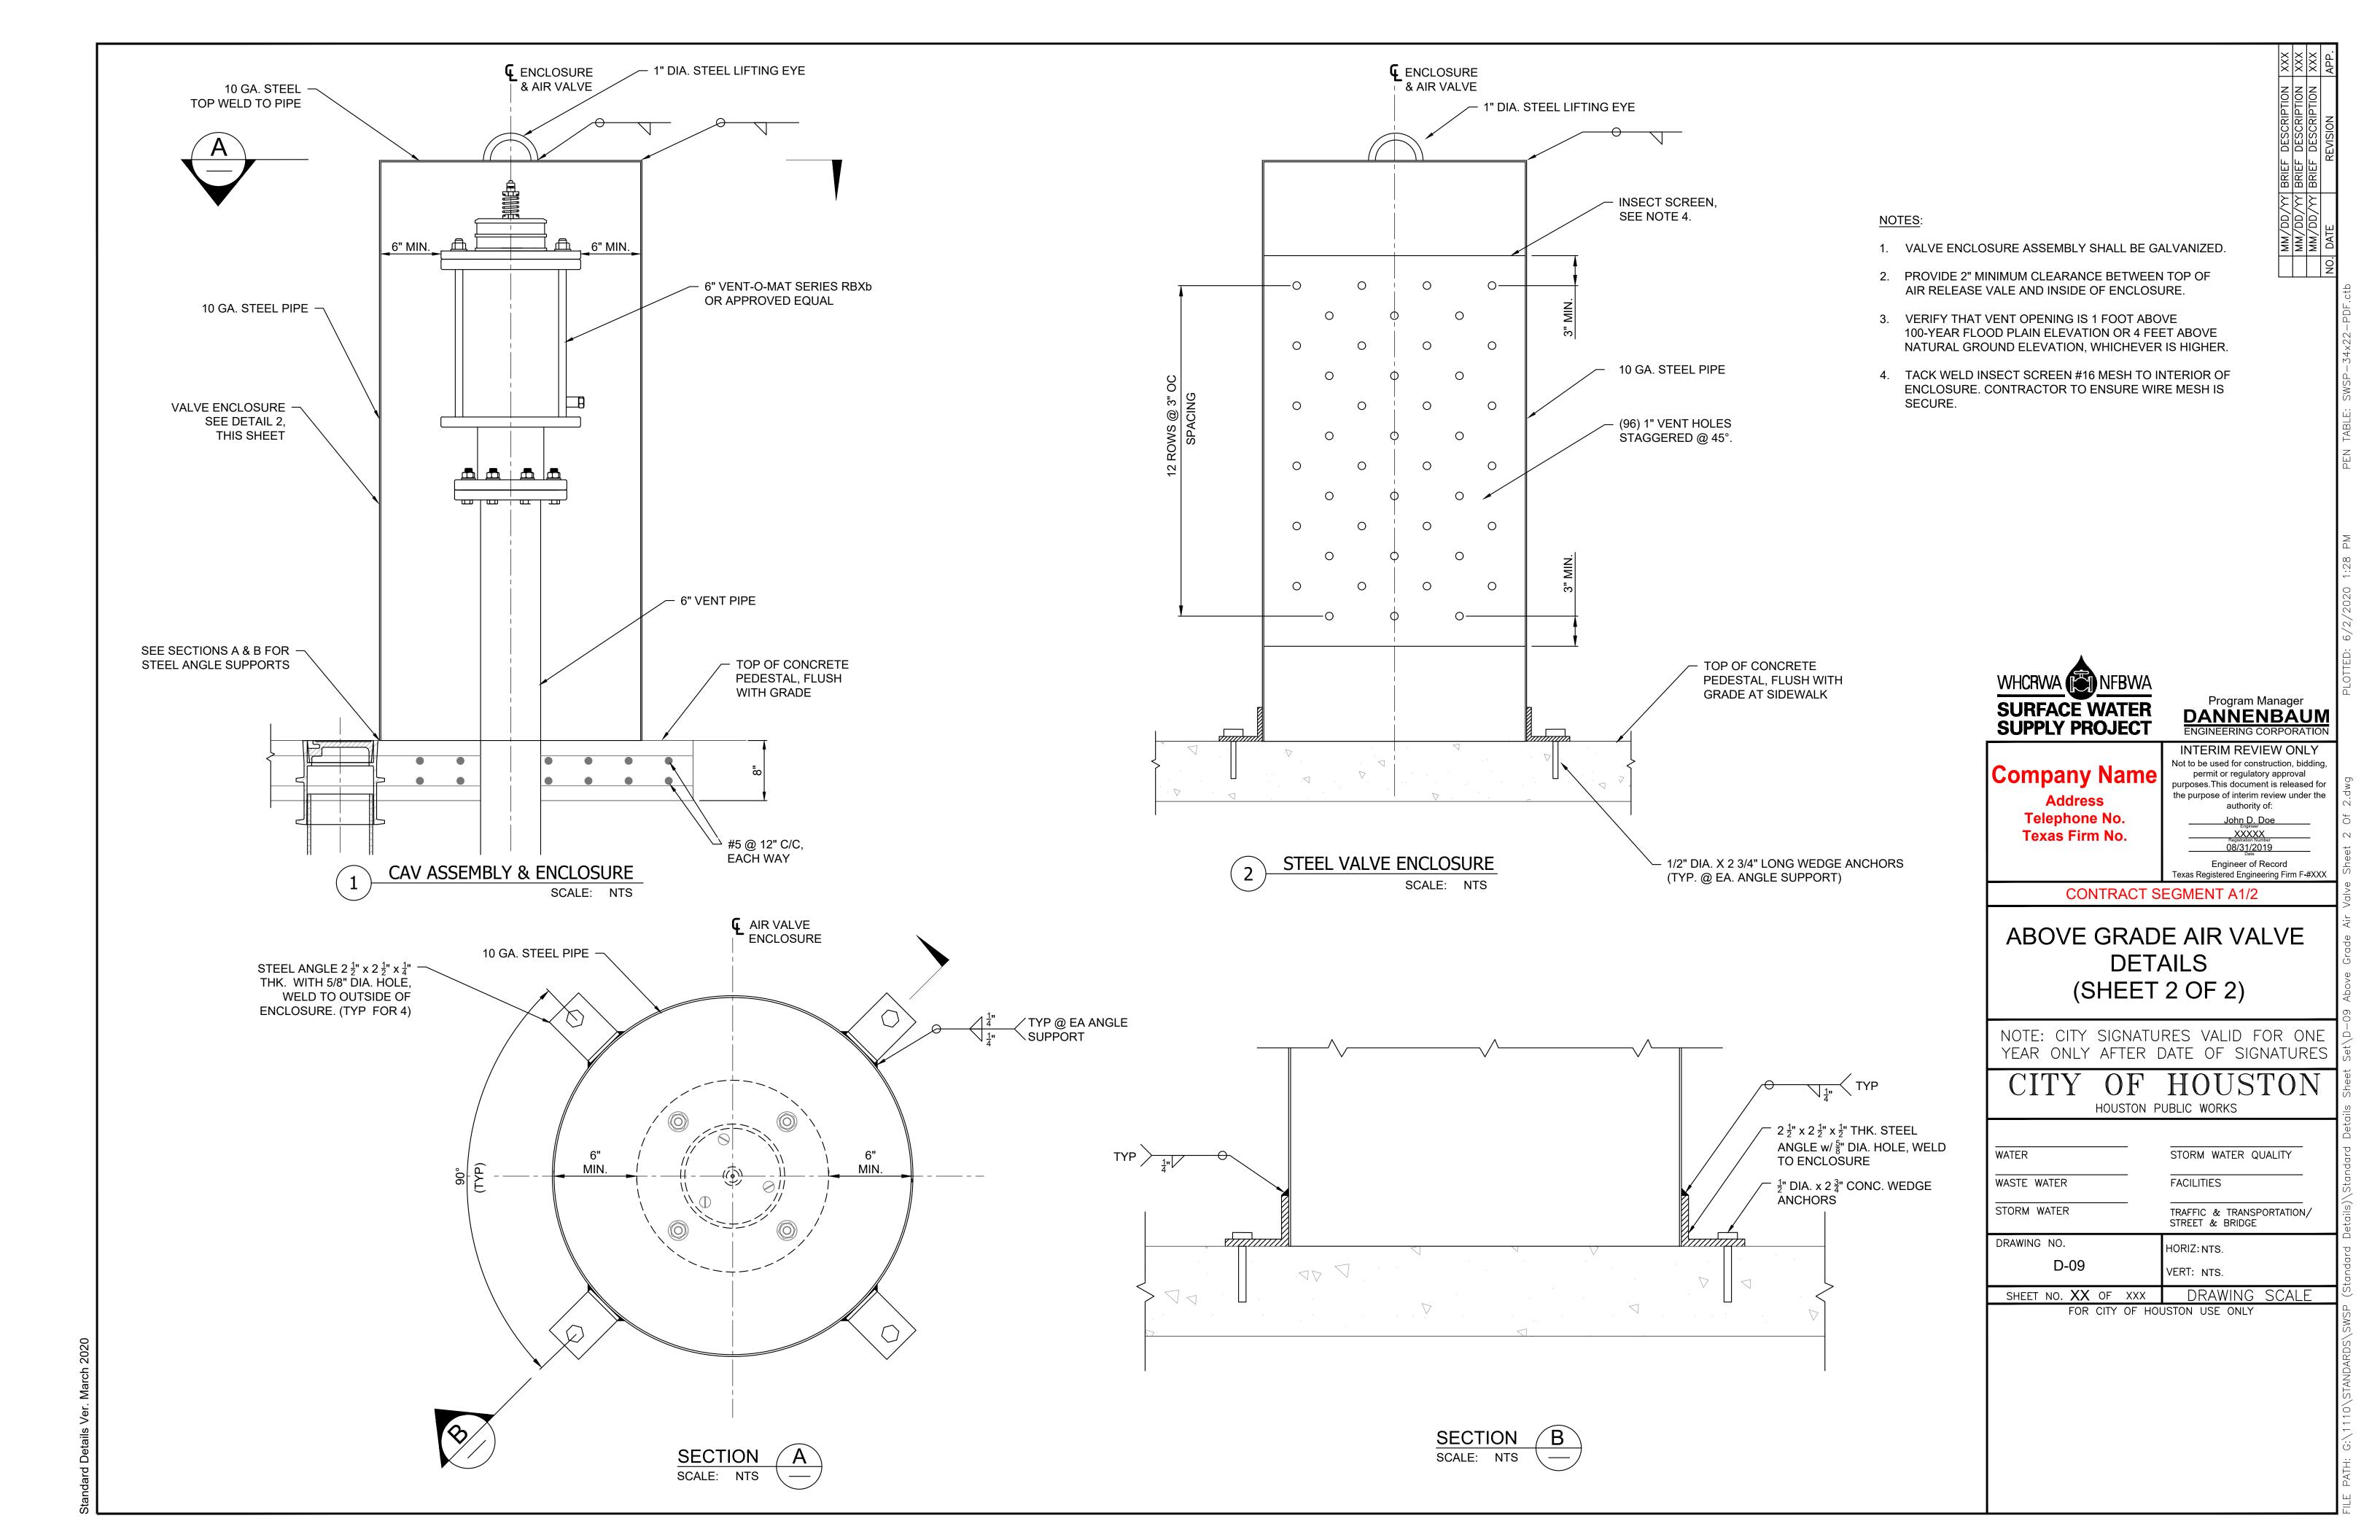


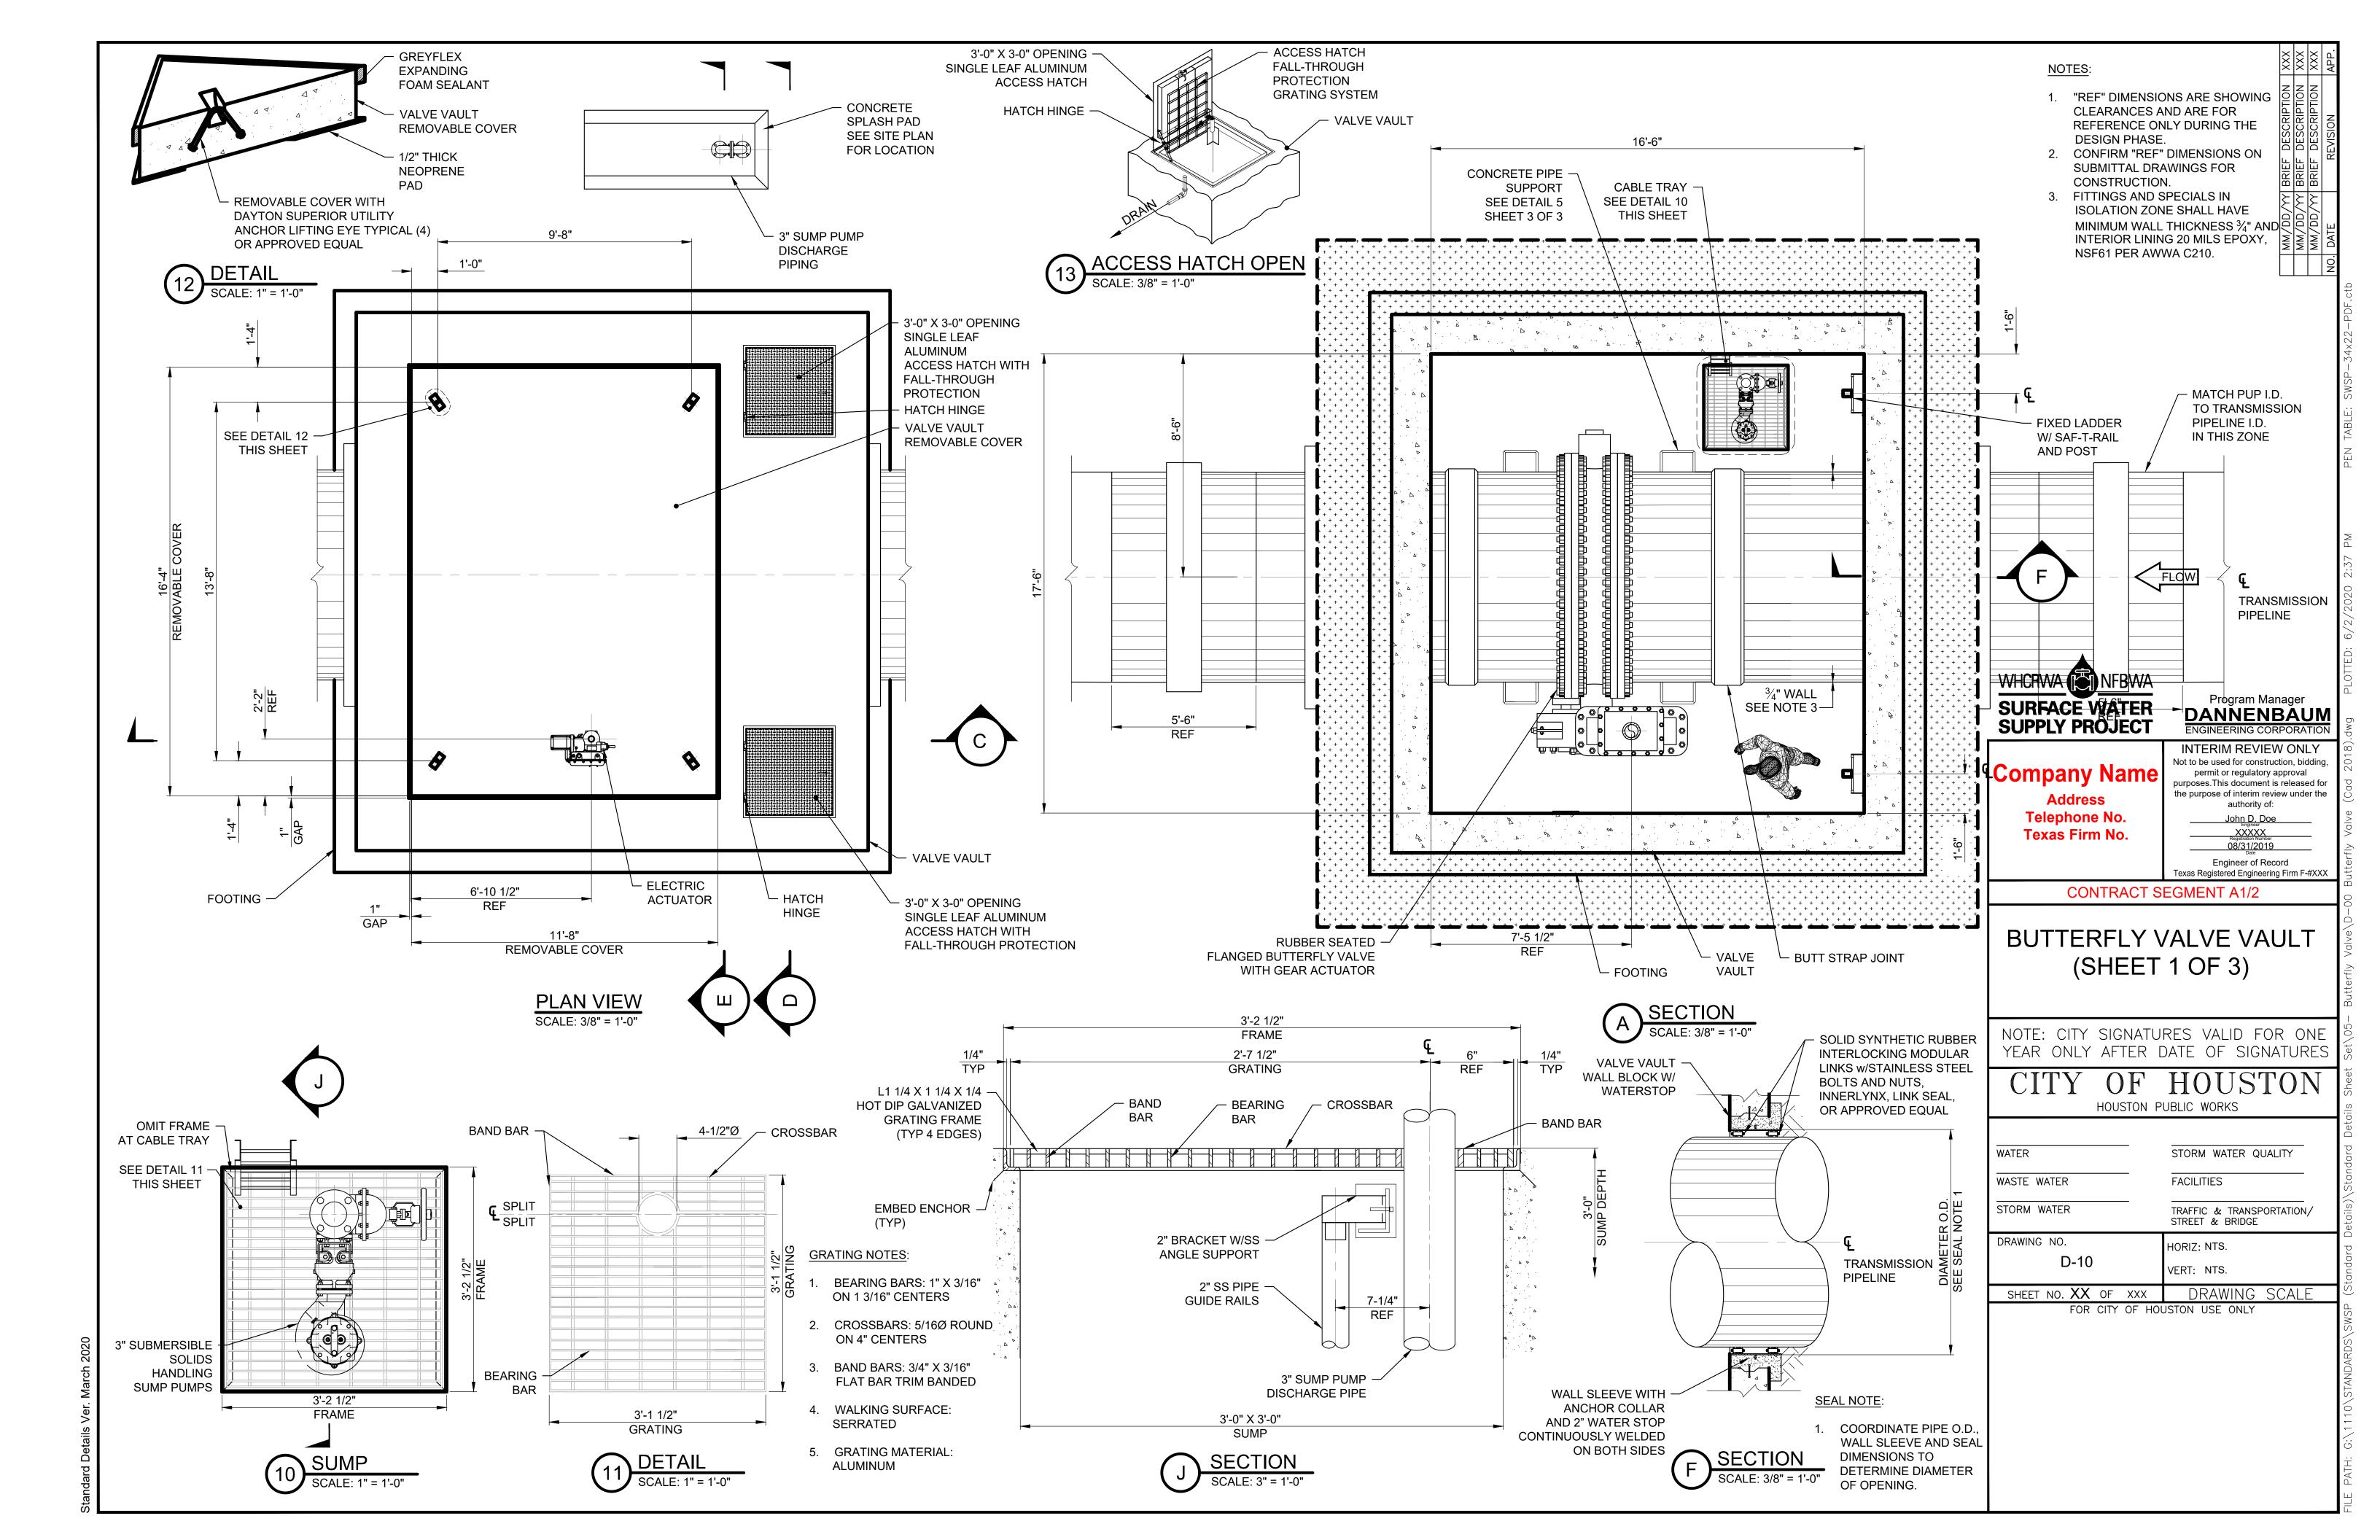

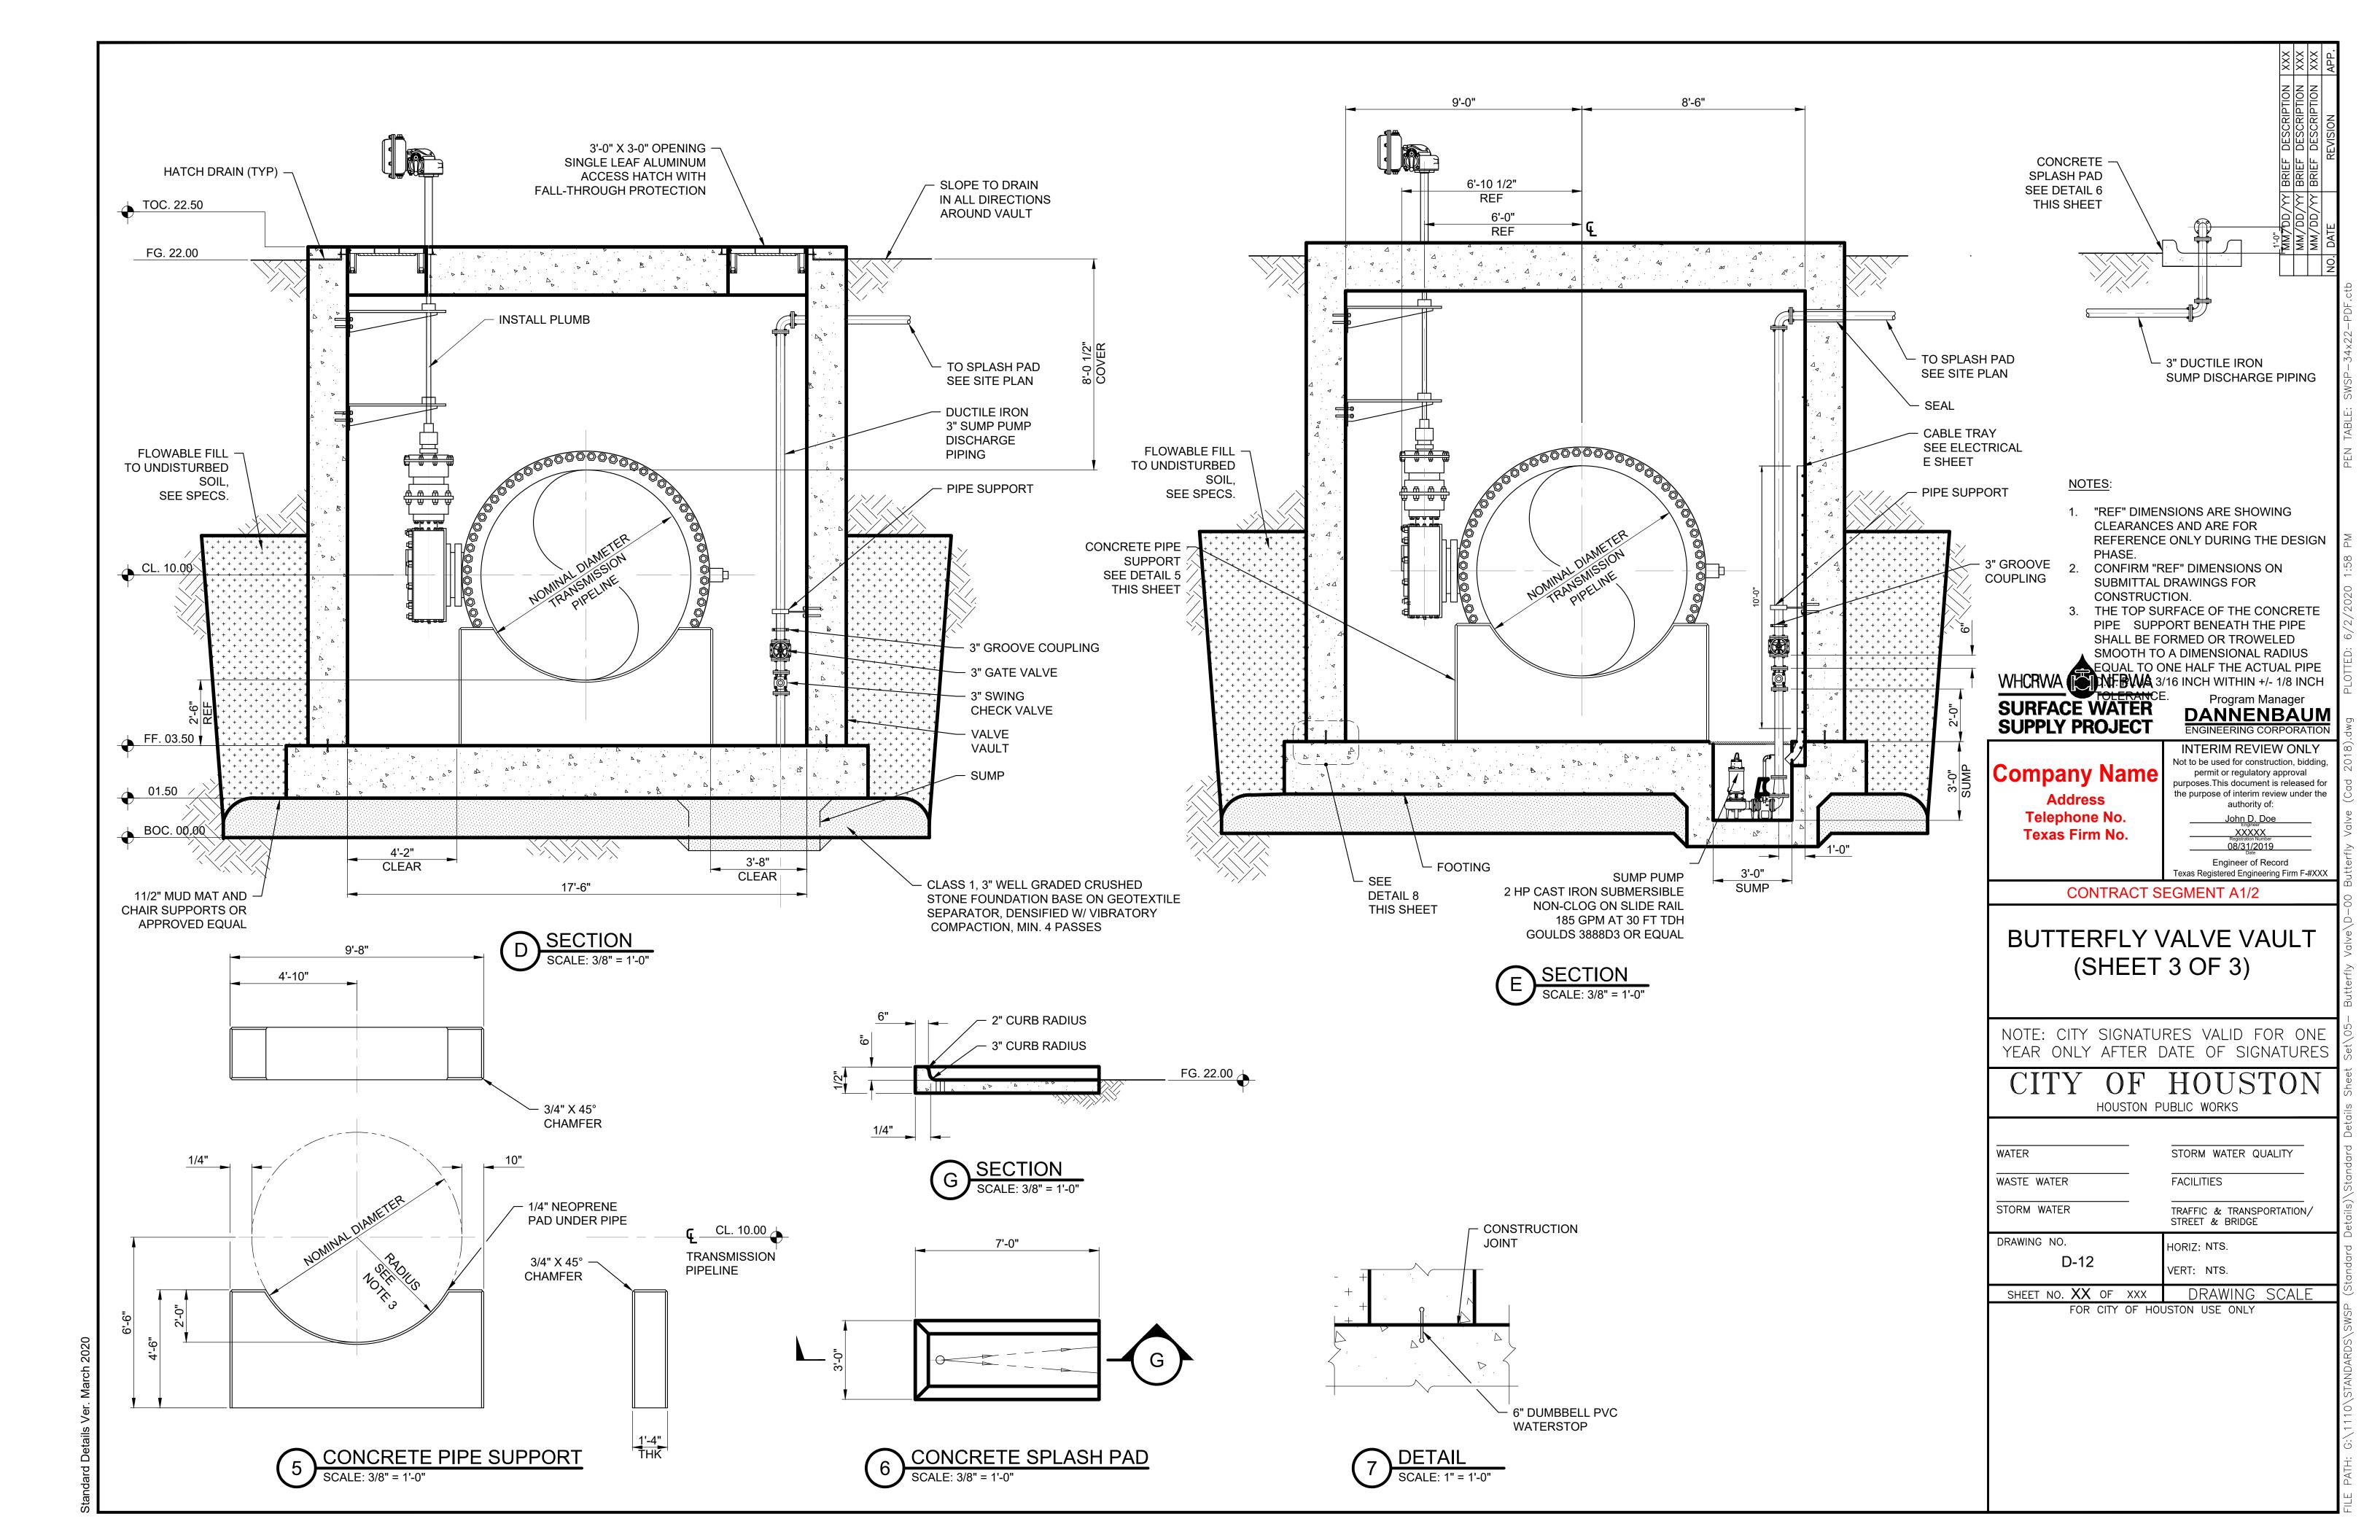


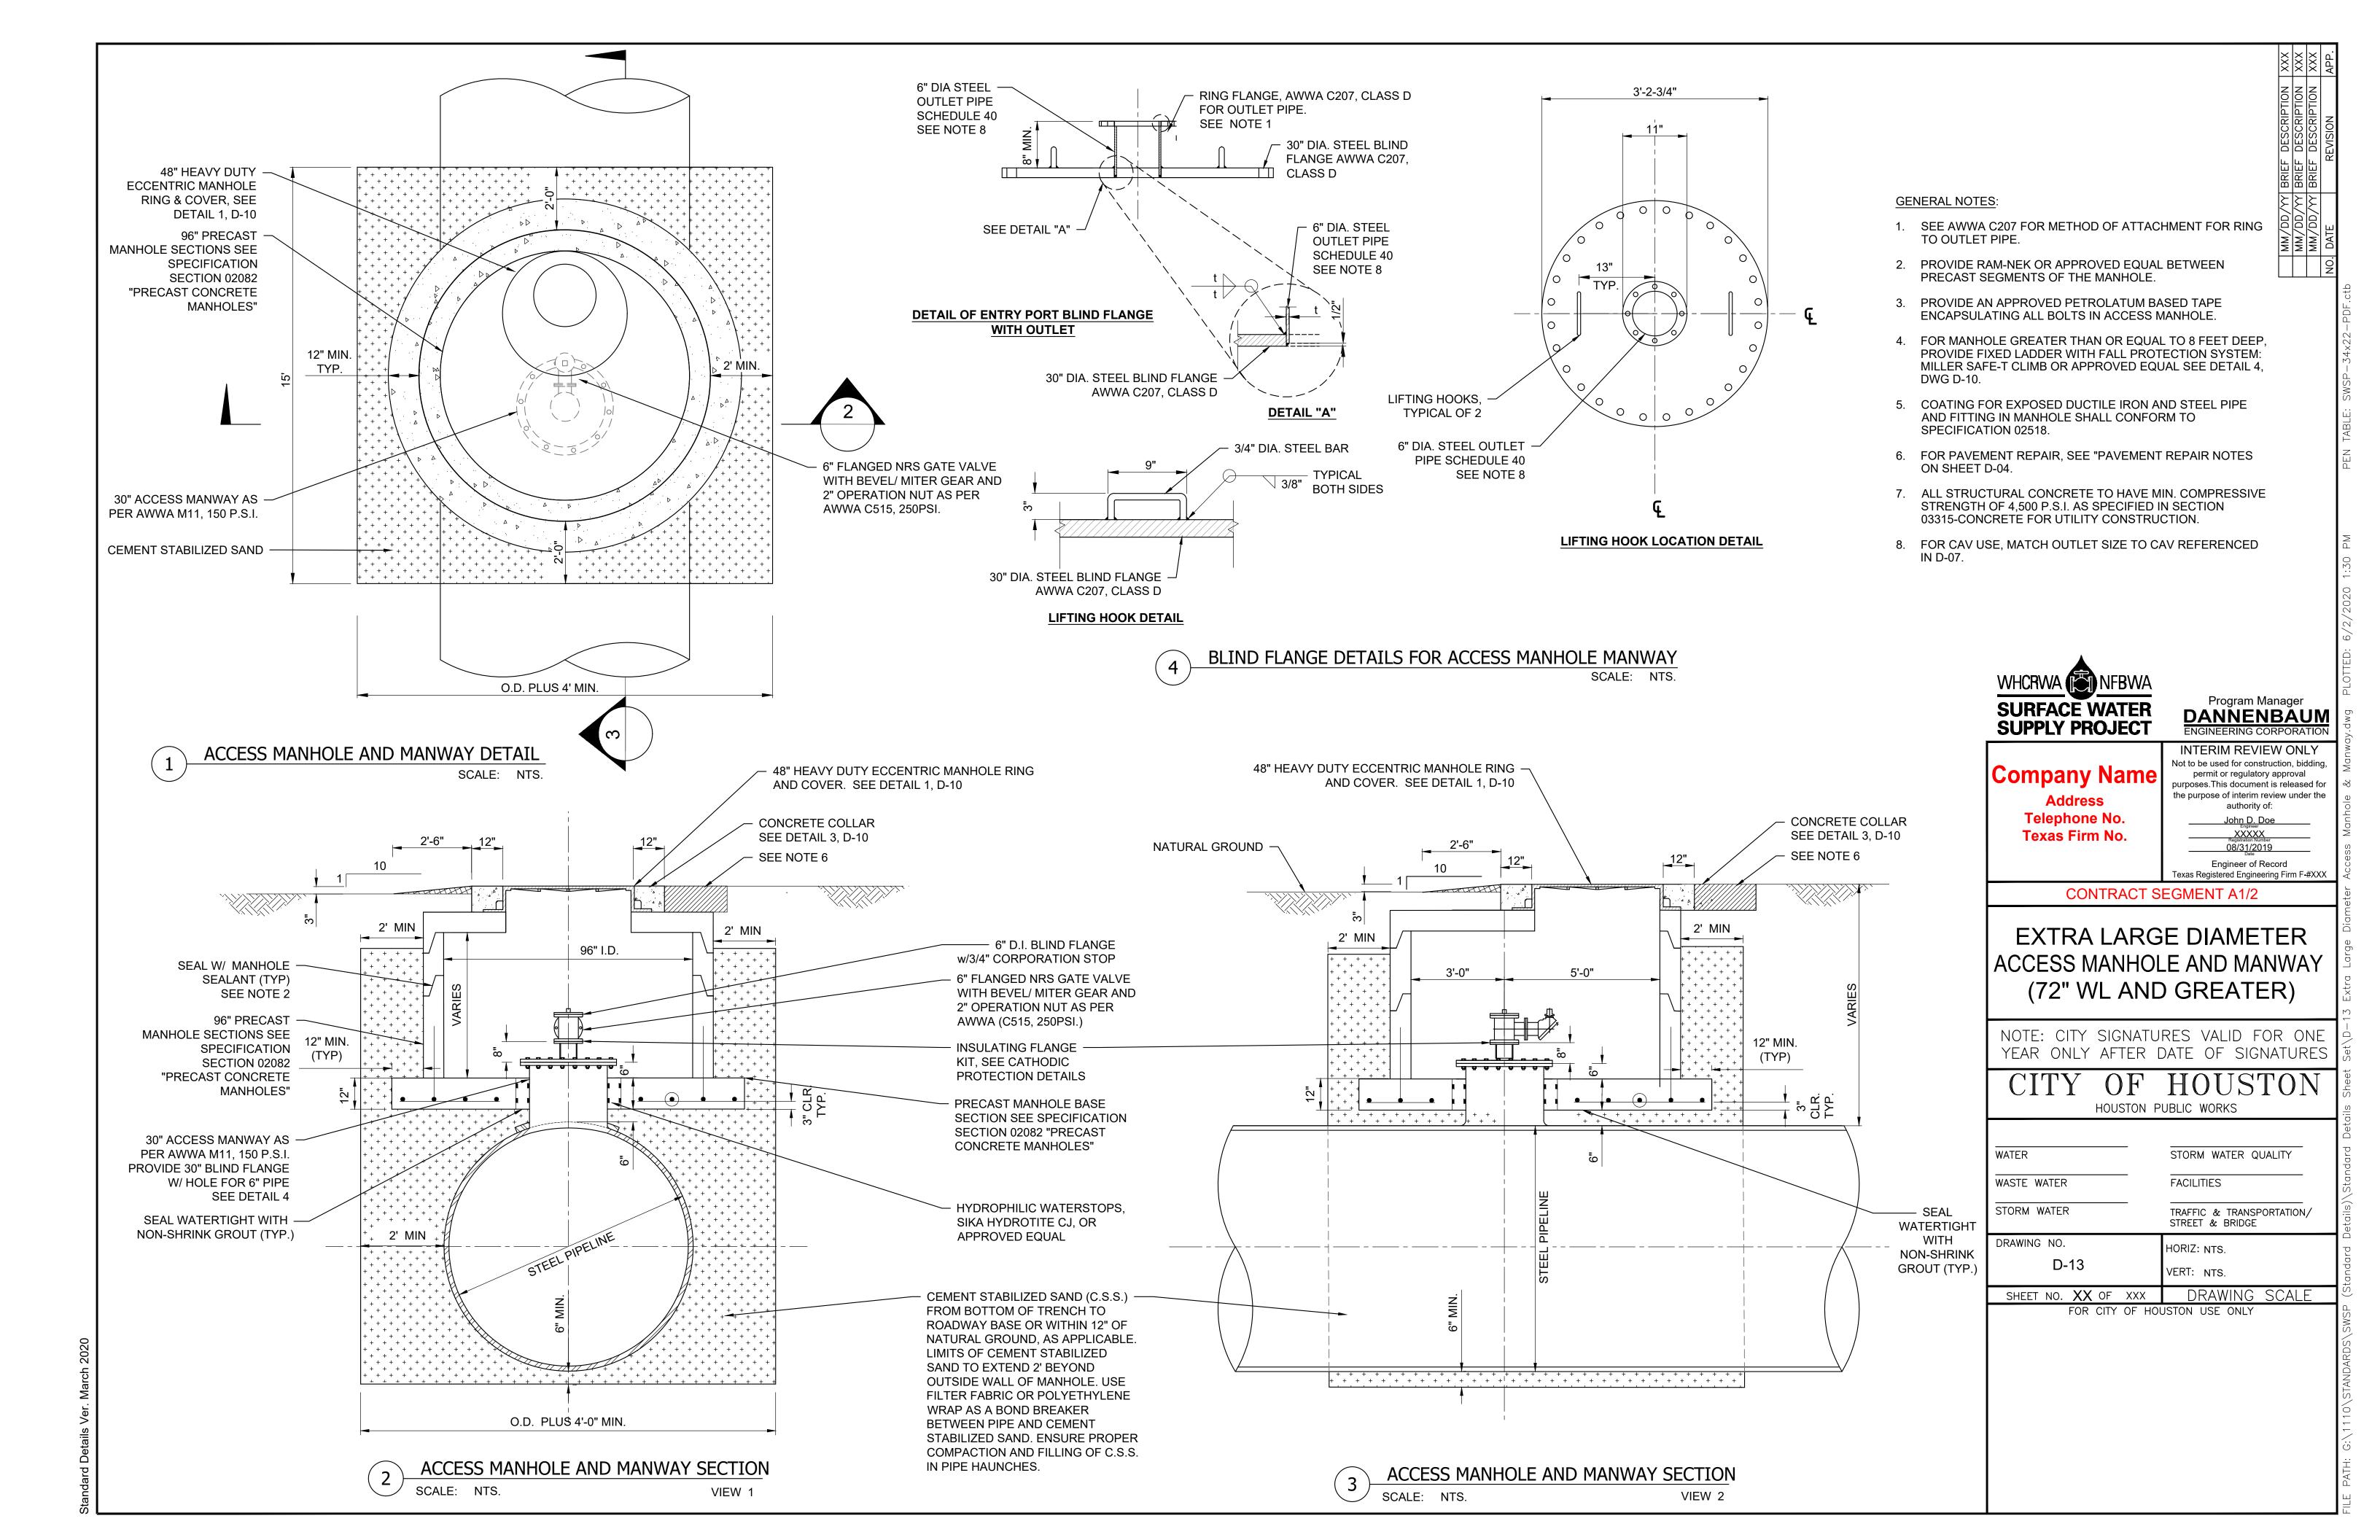

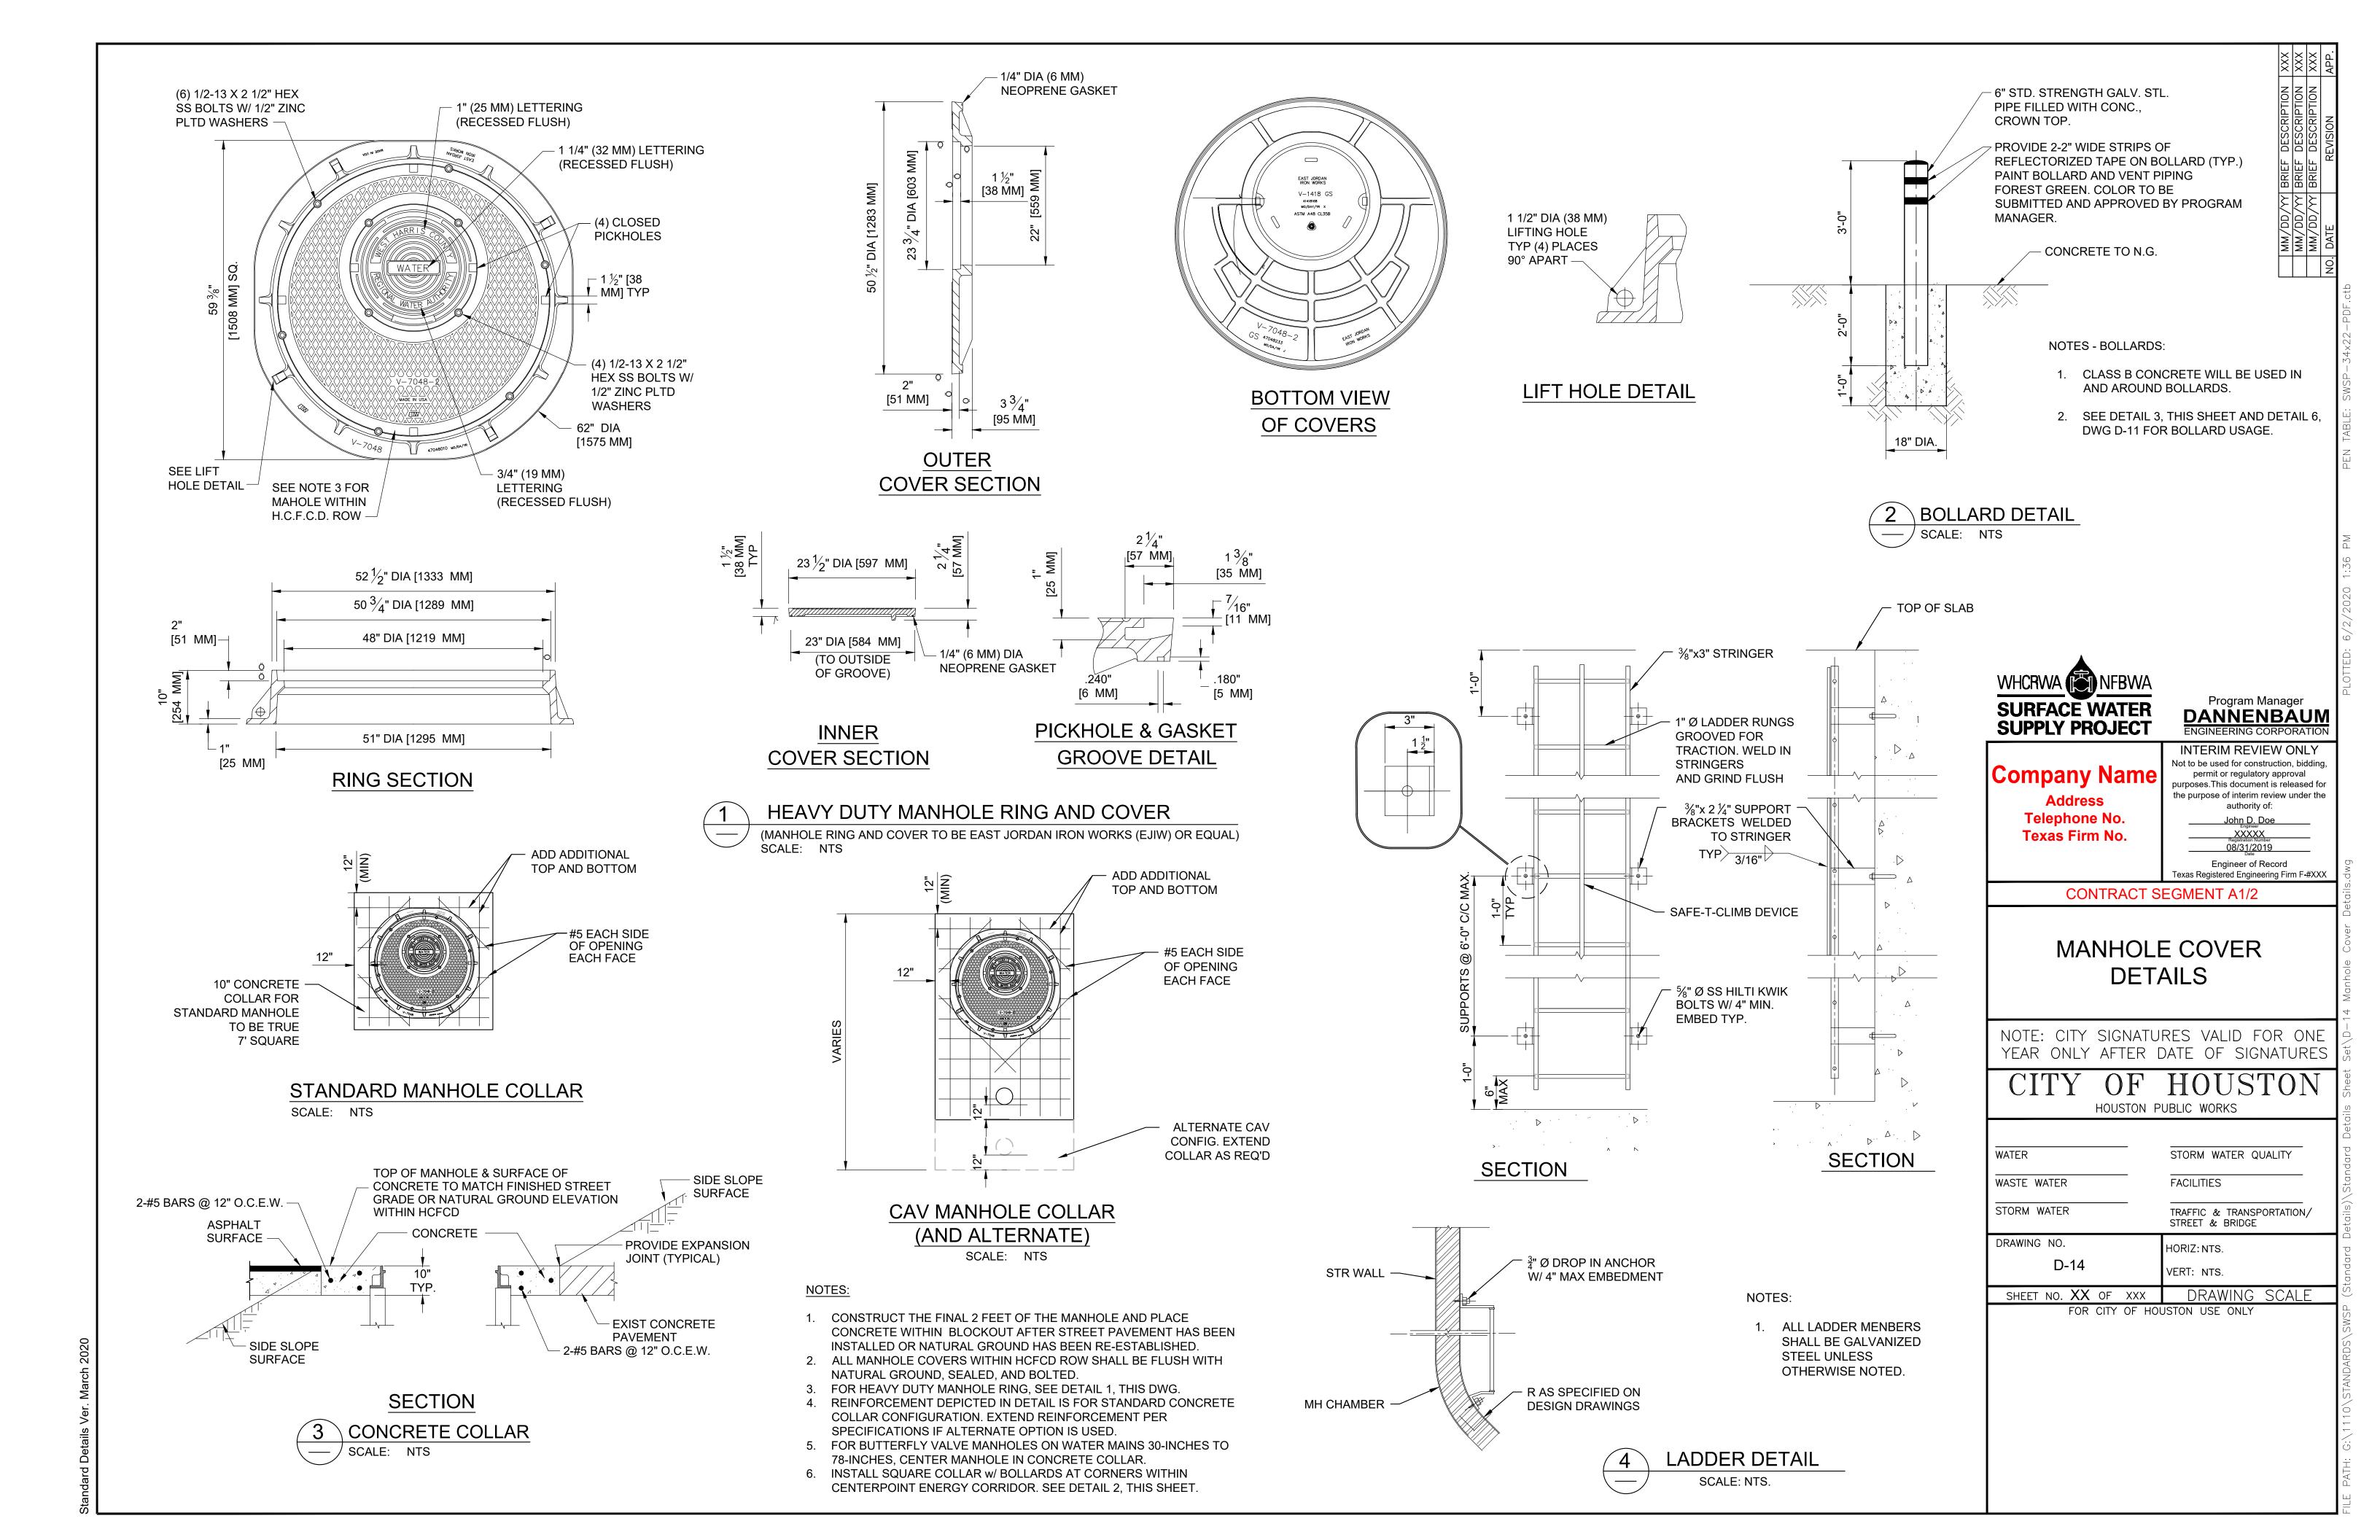

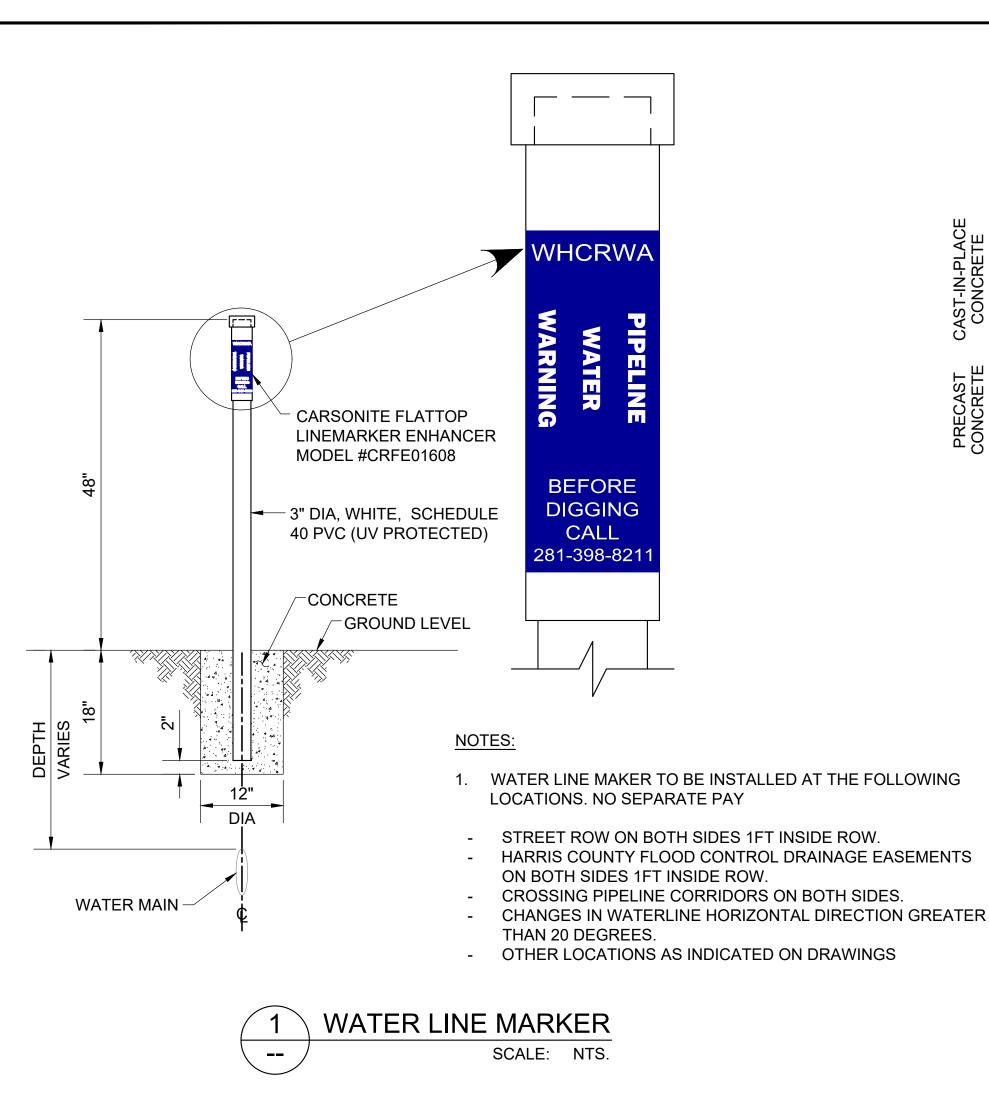

VARIES STEEL SLEEVE w/SEEP RING - 2 **-** #5 BARS TIGHT COLLAR. SEE DETAIL 4 HIS SHEET **POLYSULFIDE SEALANT EXTERIOR SIDE ONLY** - & PIPE FILL VOID BEHIND PIPE SOLID SYNTHETIC RUBBER SLEEVE w/NON-SHRINK INTERLOCKING MODULAR LINKS GROUT w/STAINLESS STEEL BOLTS AND NUTS, THUNDERLINE LINK SEAL, PVC WATERSTOP OR APPROVED EQUAL OR APPROVED EQUAL

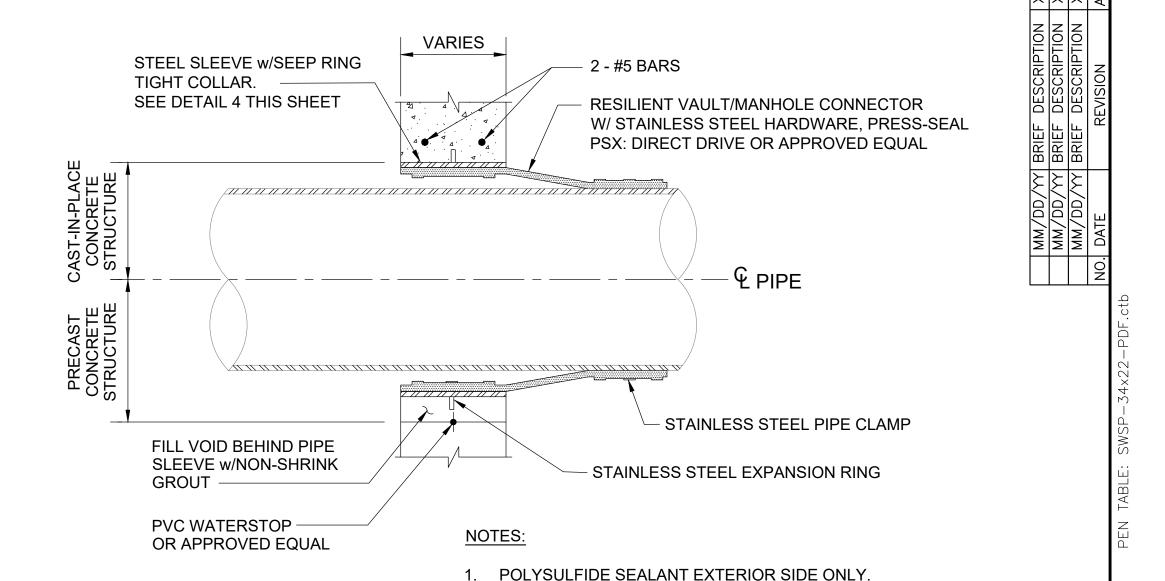

APPROVED EQUAL.

SLEEVE.

TYPICAL WALL PENETRATION DETAIL SCALE: NTS.

VARIES

SURFACE WATER SUPPLY PROJECT

2. SOLID SYNTHETIC RUBBER INTERLOCKING MODULAR LINKS

w/STAINLESS STEEL BOLTS AND NUTS, THUNDERLINE LINK SEAL, OR

FOR WALL PENETRATION INCLUDING EXTRA REINFORCING. DETAILS

TO BE SEALED BY A PROFESSIONAL ENGINEER LICENSED IN TEXAS.

3. IF MANHOLE IS CAST IN PLACE CONSTRUCTION, PROVIDE DETAIL(S)

4. CAST OR CORE PENETRATION W/IN MANUFACTURER'S SPECIFIED

TOLERANCES FOR THE PRODUCT. INSTALL CONNECTOR PER

COORDINATE WITH SEAL MANUFACTURER FOR SIZE OF STEEL

MANUFACTURER RECOMMENDATIONS.

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Program Manager

|Company Name **Address** Telephone No. **Texas Firm No.**

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SEGMENT "X"

STANDARD WATER LINE DETAILS

NOTE: CITY SIGNATURES VALID FOR ONE YEAR ONLY AFTER DATE OF SIGNATURES

OF HOUSTON HOUSTON PUBLIC WORKS


WATER STORM WATER QUALITY WASTE WATER **FACILITIES**


STORM WATER TRAFFIC & TRANSPORTATION/ STREET & BRIDGE DRAWING NO. HORIZ: HORIZ

D-15 VERT: VERT SHEET NO. XX OF XXX DRAWING SCALE


FOR CITY OF HOUSTON USE ONLY

STEEL SLEEVE W/SEEP RING SCALE: NTS.

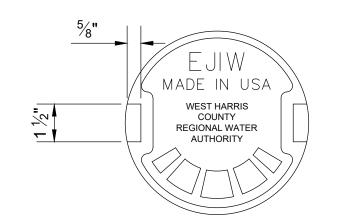

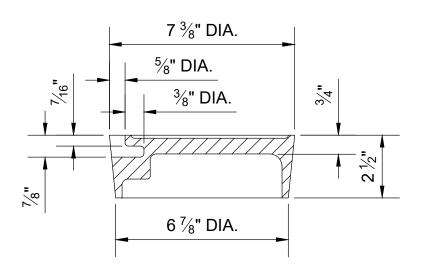



VALVE BOX COVER DETAIL (EAST JORDAN IRON WORKS (EJIW) OR EQUAL) SCALE: NTS.

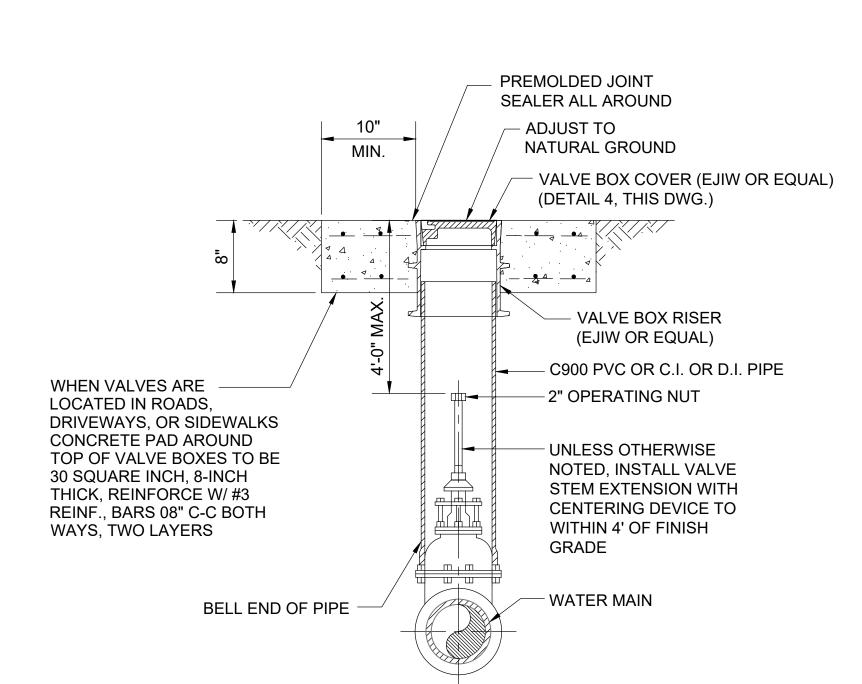




1. ~ WEIGHTS FRAME - 45 LBS, COVER - 10 LBS 2. MATERIAL - GRAY IRON ASTM A48 CL35B

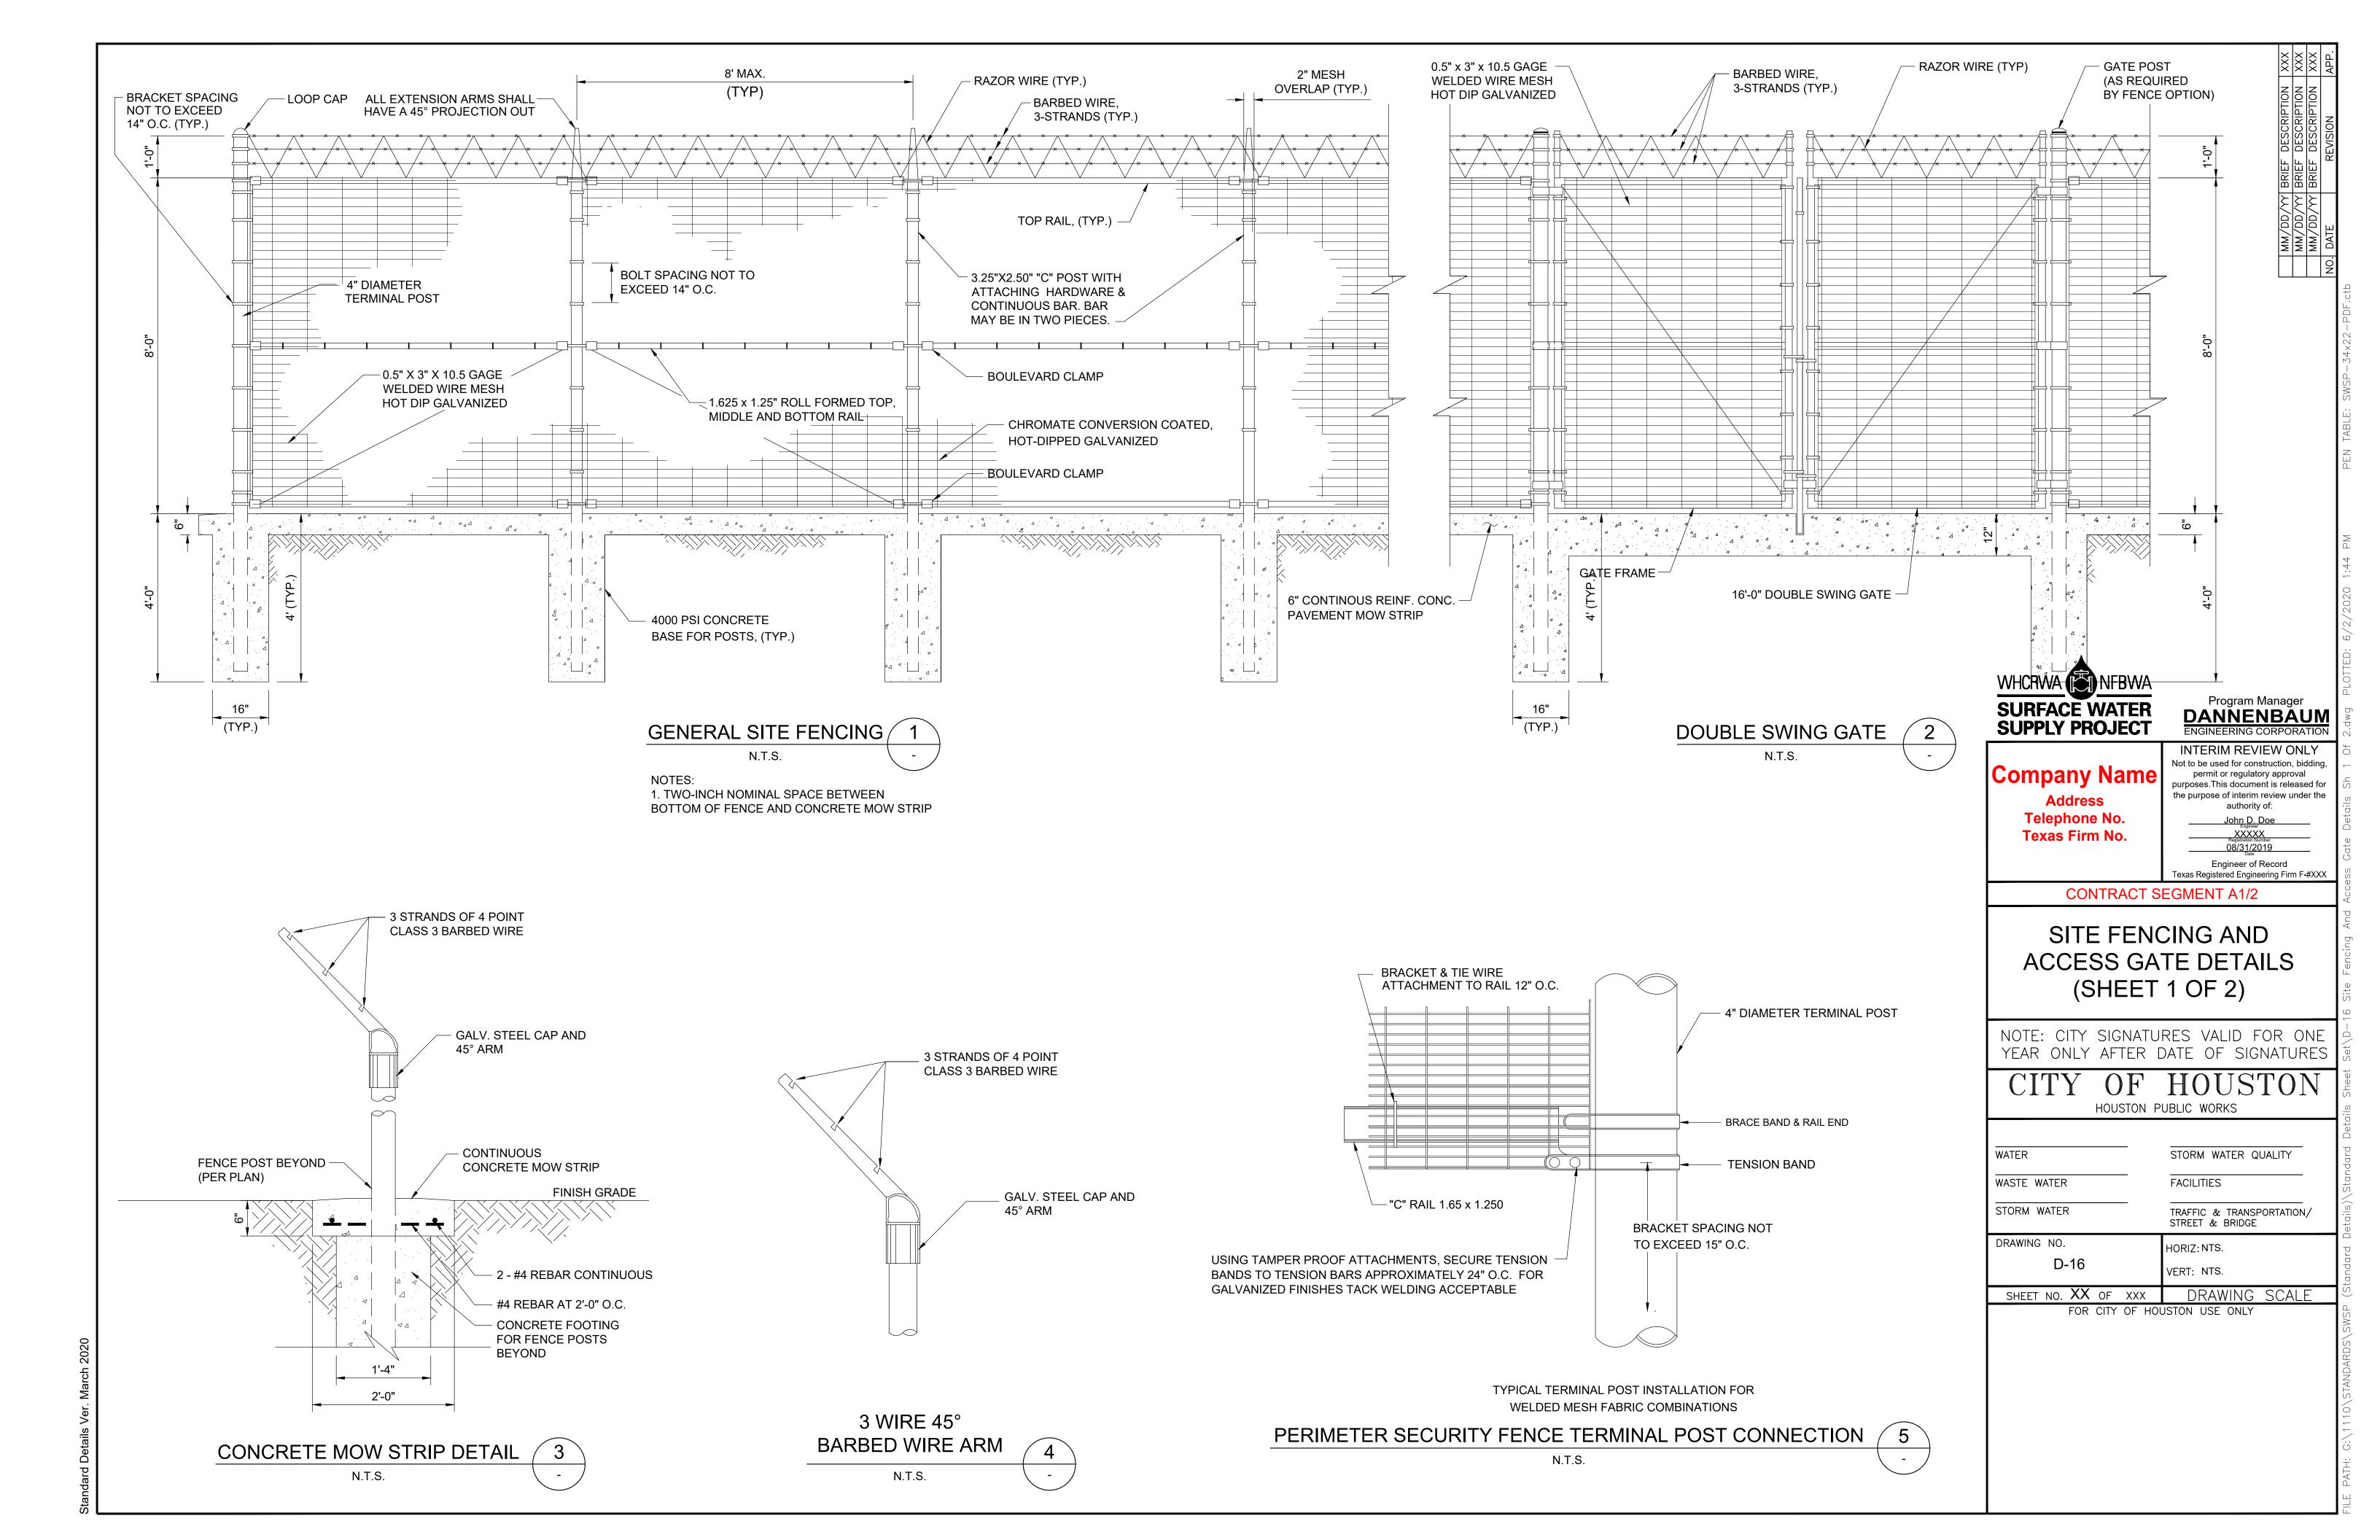


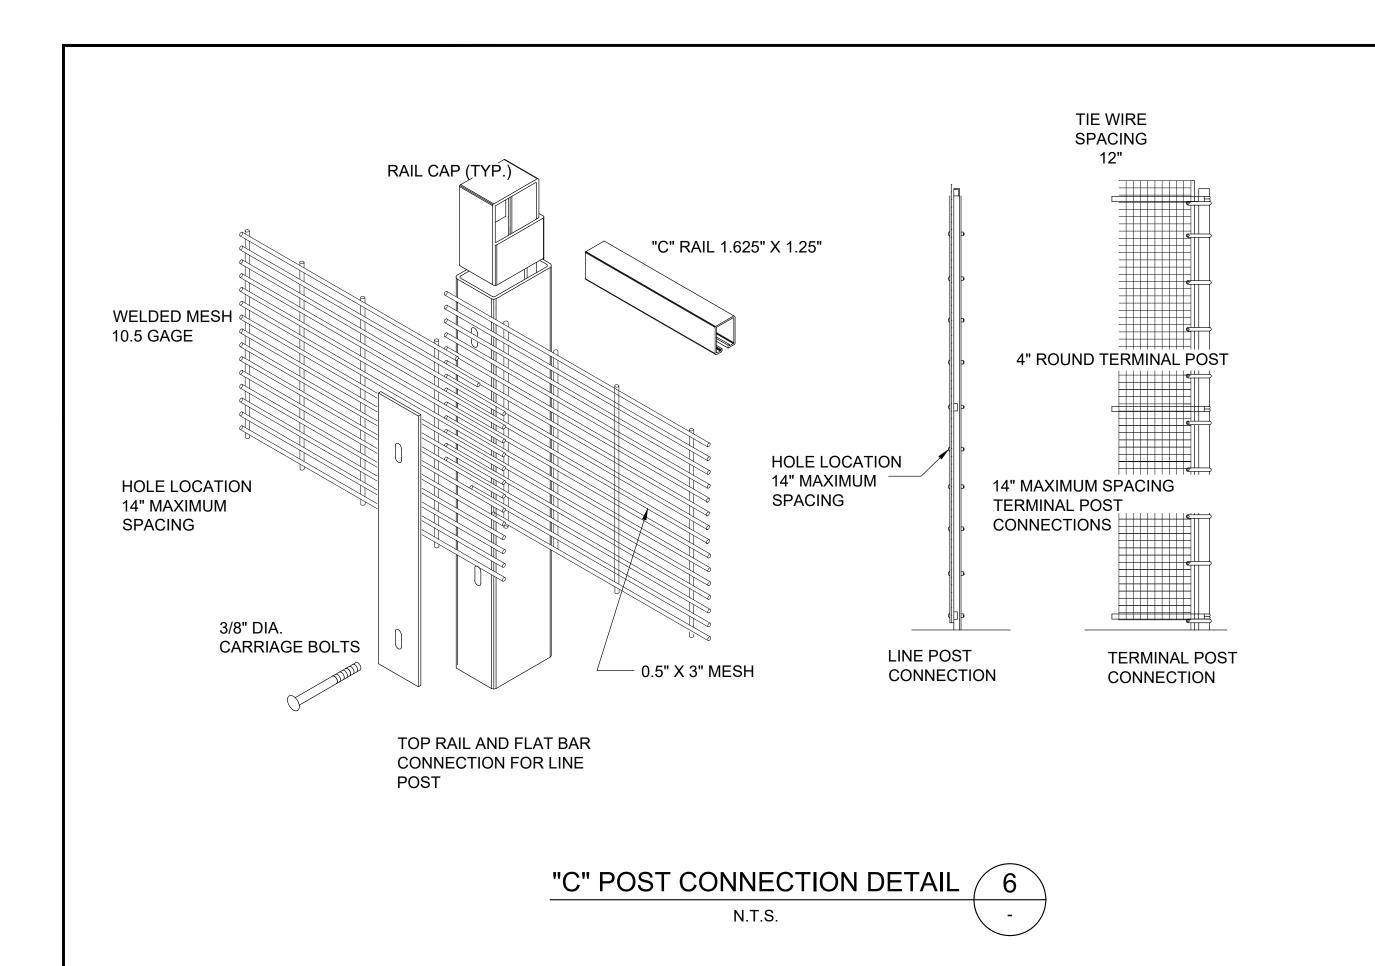


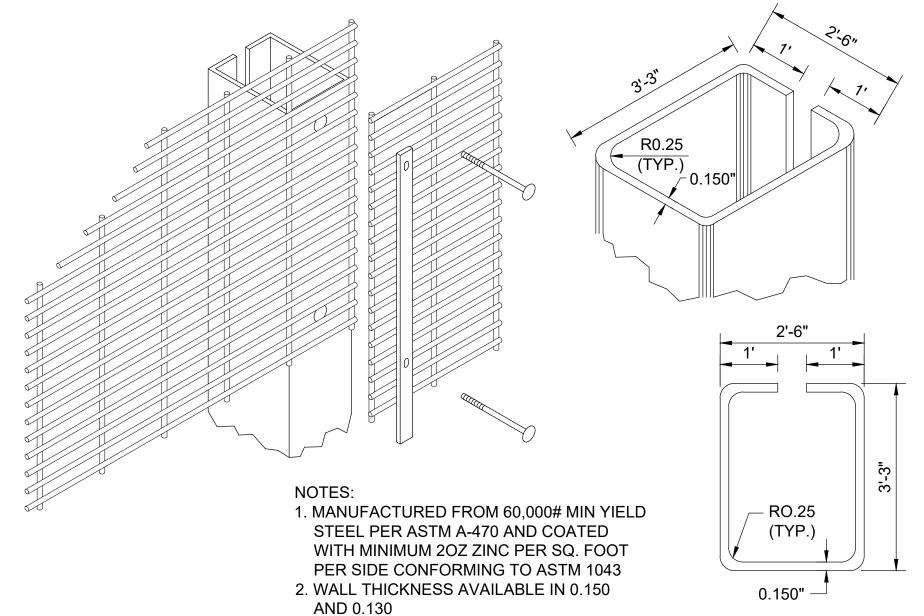

FENCE POST CONNECTION w/CONTINUOUS BAR

N.T.S.

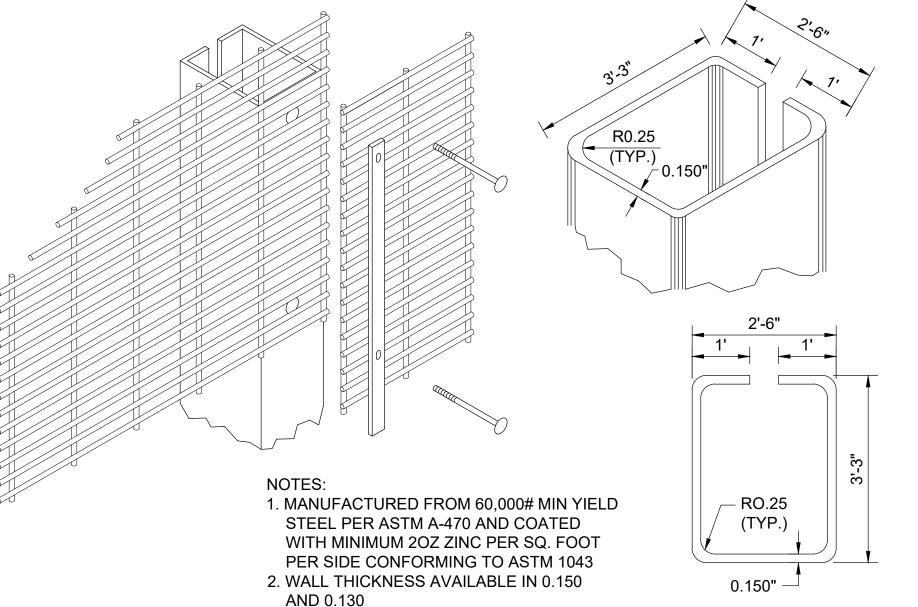

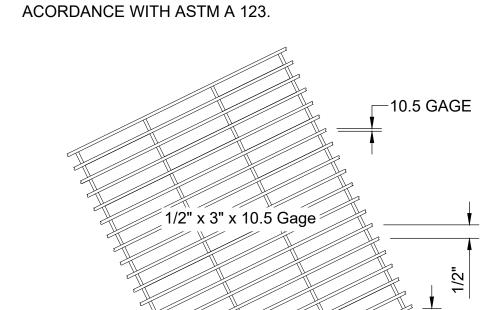

SHALL BE FABRICATED FROM LOW CARBON STEEL WIRE

TENSILE STRENGTH OF 83,000 PSI. AFTER WELDING, THE

AND ELECTRONICALLY CONTROL WELDED, FORMING A SPECIFIED MESH SIZE. THE WIRE SHALL CONFORM TO

ASTM A 853 GRADE AISI 1008, HAVING A NOMINAL

FABRIC SHALL BE HOT-DIPPED GALVANIZED IN

WELDED WIRE CORNER GUARDS:

1/2 IN. x 10.5 GA. WIRE MESH

SURFACE WATER SUPPLY PROJECT

Program Manager DANNENBAUM

INTERIM REVIEW ONLY

Company Name

Telephone No. **Texas Firm No.**

Not to be used for construction, bidding, permit or regulatory approval purposes.This document is released for the purpose of interim review under the authority of: John D. Doe

XXXXX Registration Number Engineer of Record Texas Registered Engineering Firm F-#XXX

CONTRACT SEGMENT A1/2

SITE FENCING AND ACCESS GATE DETAILS (SHEET 2 OF 2)

NOTE: CITY SIGNATURES VALID FOR ONE YEAR ONLY AFTER DATE OF SIGNATURES

OF HOUSTON HOUSTON PUBLIC WORKS

WATER STORM WATER QUALITY WASTE WATER **FACILITIES**

TRAFFIC & TRANSPORTATION/ STREET & BRIDGE STORM WATER

DRAWING NO. HORIZ: NTS. D-17 VERT: NTS.

SHEET NO. XX OF XXX DRAWING SCALE FOR CITY OF HOUSTON USE ONLY

¾" DIA. CARRIAGE BOLTS - MIDDLE OR BOTTOM "C" RAIL

- "C" POST

BOULEVARD CLAMP N.T.S.

